AGENDA City of Hobbs Planning Board – Regular Meeting August 16, 2022 at 10:00 AM

W.M. "Tres" Hicks, Chairman Bill Ramirez Brett Drennan Larry Sanderson Guy Kesner, Vice Chairman Ben Donahue Brett Clay

Tentative Agenda for the Planning Board Regular Session Meeting to be held on Tuesday, August 16, 2022 at 10:00 AM, at the City of Hobbs Annex Building, First Floor Commission Chambers located at 200 E. Broadway, Hobbs, NM 88240.

AGENDA

Call To Order and Roll Call.

- 1) Review and Consider Approval of Agenda.
- 2) Review and Consider Approval of Minutes.

July 19, 2022 – Regular Meeting

Communications from Citizens. (3-minute limit per citizen)

ACTION ITEMS

- 3) Public Hearing to Review and Consider a Special Use Map Amendment to create a Recreational Vehicle Park (RVP) Planning District per MC 18.04, located Southeast of the intersection of Navajo and Fowler at 301 E. Navajo.
- 4) Review and Consider the Vacation of a portion of Roxanna Street, Skelly Street and the east/west alleyways within Block 31, 44 and 47 of the Humble City Subdivision located within the City of Hobbs ETJ.
- 5) Review and Consider Preliminary Plan for The Subdivision of Lots 3, 4, 11 and 12, Block 1 of the Azotea Subdivision, as submitted by property owner, Host, LLC.
- 6) Review and Consider NDEY Subdivision, Unit 1 Final Plat Approval, as presented by property owner Maria Ndey.
- 7) Review and Consider Final Plat Approval Westminster Hollow, Third Village, as presented by property owner, Del Norte Heights, Inc..
- 8) Review and Consider Variance Request from MC 15.32.030 C(2) allowing a new facade sign to be emplaced with a sign face in excess of 144 square feet at 5440 A Street.

August 16, 2021 Planning Board Regular Meeting

9) Review and Consider a front yard fence height variance for 205 E. Navajo. Navajo at this location is classified as a Major Arterial and exceeds the required ROW width of 110'. The COHMTP requires a 25' front yard setback for fences on a Major Arterial, the new Fence is proposed to be a 6' Cedar Picket Fence located at the PL (+/-36' from BOC).

DISCUSSION ITEMS

10) Review proposed Ordinance to prohibit on street parking of commercial vehicles.

Adjournment.

The City will make every effort to provide reasonable accommodations for people with disabilities who wish to attend a public meeting. Please notify the City at least 24 hours before the meeting. Telephone 397-9232.

"Notice is hereby given that a quorum of the Hobbs City Commission may be in attendance at this meeting."

PLANNING BOARD MEETING

MINUTES July 19, 2022

The Hobbs Planning Board met on July 19, 2022, at 10:00 a.m. at the City of Hobbs Annex Building, First Floor Commission Chambers, located at 200 E. Broadway, Hobbs, NM 88240 with Mr. W.M. "Tres" Hicks, Chairman, presiding.

Members Present:Members AbsentW.M. "Tres" Hicks, Chairman (attended at 10:05)Guy Kesner, Vice ChairmanLarry SandersonBrett DrennanBrett ClayBen DonahueBill RamirezBill Ramirez

Also present were members of the public and City staff as follows:

Todd Randall, City Engineer Anthony Henry, Deputy Engineer Dwayne Penick, City Commissioner 5 Citizens Kevin Robinson, Development Director April Hargrove, Engineering Assistant Valerie Chacon, Deputy City Attorney

Call to Order and Roll Call

Mr. Rill Ramirez, Planning Board member, did a roll call for members as follows:

Mr. Ramirez-yes, Mr. Sanderson-yes, Mr. Kesner-absent, Mr. Drennan-absent, Mr. Clay-yes, Mr. Donahue-yes, and Mr. Hicks-yes. There were five members present at the meeting.

Mr. Ramirez called the meeting to order at 10:00 am.

1.) Review and Consider Approval of Agenda

The first item of business was to review and approve the agenda for July 19, 2022 meeting. Mr. Ramirez asked if there were any additions or changes to the agenda. Mr. Robinson stated he would like to switch items 4 and 6 of the agenda. Mr. Donahue made a motion, seconded by Mr. Sanderson to approve the agenda as amended. The vote on the motion was 4-0 and the motion carried.

2.) Review and Consider Approval of Minutes

Hobbs Planning Board Meeting Minutes, July 19, 2022 Regular Meeting, Page 2

Mr. Ramirez asked if everyone has had a chance to read the Regular Meeting Minutes from June 22, 2022. Mr. Donahue made a motion, seconded by Mr. Sanderson to approve the Regular Meeting Minutes as presented. The vote was recorded as follows: Ramirez yes, Sanderson yes, Clay yes, Donahue yes. The vote on the motion was 4-0 and the motion carried.

Communications from Citizens

There were no communications from citizens.

Action Items

3) Public Hearing to Review and Consider a Special Use Map Amendment to create a Recreational Vehicle Park (RVP) Planning District per MC 18.04, located Southeast of the intersection of Navajo and Fowler at 301 E. Navajo.

Mr. Robinson stated this is a public hearing to review and consider a special use map amendment to create a Recreational Vehicle Park (RVP) located southeast of the intersection of Navajo and Fowler at 301 E. Navajo. He explained the first step of the process of approving the Recreational Vehicle Park (RVP) is to make sure the site is compliant with Municipal Code 18.04 and for the Board to consider if it is a good location for an RV Park. He reminded the Planning Board that there has been an RV Park approved at 500 E. Navajo, but has not yet been developed. Mr. Robinson explained the main requirements are that the site has to be accessible from a collector street (or above) and the site has to be at least one acre or more property.

Mr. Ramirez opened the public meeting at 10:05 a.m.

Mr. Michael M. Mings stated he resides across the street from the location of the proposed RV Park. Mr. Mings addressed several comments to the Planning Board members. He stated he is not against an RV Park, but he is not in favor of a Mobile Home Park at that site. Mr. Mings expressed his concern regarding the traffic and stated there is enormous traffic from Fowler and Navajo to the Lovington Highway. Mr. Mings stated he is in the process of requesting a variance for a 6 feet red wood cedar fence to be placed in front of his home to help with the noise of the traffic. Mr. Mings further expressed his concerns regarding the extra traffic the RV Park could create. He stated the more businesses that come in the busier it gets. He is concerned about potential accidents at the intersection.

Mr. Dwayne Penick stated that he has spoken to the Executive Director of Habitat for Humanity, Richard Sanchez, and explained the RV Park is planned for volunteers coming in to help construct houses.

Mr. Hicks commented on the location of the RV park and stated he would like for the park to be limited to the south half of the property.

Mr. Larry Sanderson, Planning Board member, stated there are a lot of RV spaces around the area with a lot of empty spaces, what's the need to create another park.

Hobbs Planning Board Meeting Minutes, July 19, 2022 Regular Meeting, Page 3

Mr. Robinson explained we are a use by right community and have the right to utilize your property as you see fit providing you are compliant with Municipal Code 18.04. Mr. Robinson echoed the first step is for the Planning Board to consider if the site is compliant with the rules and regulations. The second step is to review and consider the design standards.

Mr. Brett Clay, Planning Board member, expressed his concern regarding the visibility of the RV Park. He stated he did not want an RV park to be visible from the street.

Mr. Sanderson made a motion, seconded by Mr. Clay to deny the Special Use Map Amendment to create a Recreational Vehicle Park. Mr. Sanderson stated he would like staff to communicate the concerns with the owner and bring the plans back to the Planning Board once the concerns have been addressed. Additionally, he would like more detailed information about the RV Park. The vote on the motion was 5-0 and the motion carried. The public meeting adjourned at 10:47 a.m.

6) Review and Consider Preliminary Plan for The Bender Trails Subdivision, as submitted by property owner, Nadeem Kassis.

Mr. Kevin Robinson stated this is the preliminary plan for the Bender Trails Subdivision, submitted by the property owner, Nadeem Kassis. Mr. Robinson stated the engineering plans set have been submitted to the municipality.

Mr. Todd Randall, City Engineer, stated City staff has reviewed the plans but has not made final comments. He stated there may be minor modifications to the drainage. Mr. Randall stated a portion of this development will drain into a privately-owned detention pond. The engineer, Mr. Jeremy Baker, discussed the drainage plans for the Bender Trails Subdivision. Mr. Randall commented on the slopes of the drainage. Mr. Randall stated this is conditional and will need to be resubmitted for final comments from City staff and the Utilities Department.

In response to Mr. Ramirez's question, Mr. Randall stated they are proposing for all underground utilities.

Mr. Sanderson made a motion with the condition to resolve any City staff comments, seconded by Mr. Donahue. The vote on the motion was 5-0 and the motion carried.

4) Review and Consider a front yard fence height variance for 4401 W. Business Park Boulevard. Business Park at this location is classified as a Minor Arterial and between Lovington Highway and Millen either meets or exceeds the required ROW width of 110'. The COHMTP requires a 25' front yard setback for fences on a Minor Arterial, the new Fence is proposed to be a 6' solid wall R-Panel Fence located at the PL (25' from BOC).

Mr. Robinson stated this is a request for a front yard fence height variance for 4401 W. Business Park Boulevard. Mr. Robinson stated this is an existing fence that has been in place prior to the adopted rules and regulations. He stated Business Park Boulevard location is classified as a minor arterial and between Lovington Highway and Millen either meets or exceeds the required right-of-way width of 110'. The City of Hobbs Major Thoroughfare Plan requires a 25' front yard setback for fences on a minor arterial road. Mr. Robinson stated the new fence is proposed to be a 6' solid wall R-panel fence located at the PL (25' from BOC).

In response to Mr. Hicks's question, Mr. Robinson stated the County wants to place a solid wall R-panel fence due to the type of usage of the Lea County Convenience Center. They want to restrict the visibility from the roadway.

Mr. Ramirez made a motion to approve the variance, seconded by Mr. Sanderson. The vote on the motion was 5-0 and the motion carried.

5) Review and Consider Dedication Plats for properties located east of 1101 W. Joe Harvey.

Mr. Robinson stated these are the dedication plats for properties located east of 1101 W. Joe Harvey. Mr. Robinson stated the municipality has granted preliminary plat approval for Centre Point Subdivision. Mr. Robinson explained the dedication plat will make the private roadway into a public roadway. He stated the infrastructure is public infrastructure granted with an easement. Mr. Robinson explained everything within the dedication will become public property and will be required to be maintained by the municipality. In response to Mr. Hicks's question, Mr. Robinson stated the preliminary plat for the Centre Point Subdivision was approved with the comment that the property located east of 1101 W. Joe Harvey be dedicated to the municipality and become public property.

Mr. Ramirez made a motion, seconded by Mr. Donahue to approve the dedication plat as presented. The vote on the motion was 5-0 and the motion carried.

Discussion/Updates

None

Adjournment

With nothing further to discuss Mr. Sanderson made a motion, seconded by Mr. Ramirez to adjourn. The meeting adjourned at 11:07 am. The vote on the motion was 5-0 and the motion carried.

W.M. "Tres" Hicks, Chairman

August 16, 2021 Planning Board Regular Meeting

3) Public Hearing to Review and Consider a Special Use Map Amendment to create a Recreational Vehicle Park (RVP) Planning District per MC 18.04, located Southeast of the intersection of Navajo and Fowler at 301 E. Navajo.

01 March 2022

Presented to:

Kevin Robinson

City of Hobbs

Submitted by:

Richard Sanchez

Habitat for Humanity of Hobbs, NM Area

301 E. Navajo Dr.

P.O. Box 5833

Hobbs, NM 88241-5833

575-390-5475

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- **B. Board of Directors**
- C. Organizational Chart
- D. Documentation that the Applicant is duly organized under State law

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Development Summary

Habitat for Humanity is proposing to develop a RV park for traveling volunteers called Care-A-Vanners. Habitat for Humanity International's RV Care-A-Vanners come to Hobbs, New Mexico for 9 months out of the year to assist local families in need of an affordable home. In partnership with our Habitat affiliate, care-a-vanners will be here for two weeks at a time, helping construct a Habitat home located in Hobbs. The RV Care-A-Vanner Program, which is coordinated through HFHI Headquarters in Americus, Georgia, matches volunteers who travel in recreational vehicles with local Habitat affiliates in need of skilled volunteer support. The RV Care-A-Vanners camp in their RVs while working shoulder to shoulder with the local Habitat staff, local volunteers, and future Habitat homeowners.

RV Care-A-Vanners come from all over North America and from all walks of life—doctors, lawyers, engineers, corporate managers, mechanics, truck drivers, carpenters, plumbers, electricians, etc. The majority being near or at retirement age, their construction skills range from professional to first-time builder. The RV Care-A-Vanners, who typically stay for two weeks, pay their own expenses to travel to these organized Habitat building projects. Drawing from a pool of more than 6,000 volunteers, this year teams of RV Care-A-Vanners are participating in 250 building projects from Canada to Florida and California to Maine.

Habitat for Humanity of Hobbs is a very popular destination spot for Care-A-Vanners. We provide them a RV spot, free of charge. Also, our board is very generous in providing meals and many different outlets of entertainment. Habitat for Humanity's ministry is built around providing low-income housing, so we share the city's commitment in helping the city to alleviate the shortfall of low-income housing.

This RV Park will allow us to continue to build low-income housing.

II. Design Narrative

The RV Park will consist of ten spaces that will comply with all city ordinances and by-laws. Each space will be 35 feet wide by 70 feet deep, for each recreational vehicle. This will consist of two rows of five spaces each, covering an area 175 foot wide by 140 deep. This parking area will be 460 feet away from Navajo Dr., situated behind the Restore and Shop. There will be a required buffer of thirty feet off the western property line we share with the Sorrento Apartments. We will place our mobile office in the northeastern space to utilize as a guard house and laundry facility. There has been a fence erected around this area.

These spaces will each be served by city water, sewer, and Xcel electrical power which will meet all building codes required of an RV Park. This area has irrigation lines in place, and we would like it to have a park like setting, with trees and grass in the near future.

This park will not be open to the public. It will be for volunteers at Habitat for Humanity of Hobbs.

III. Development Team Experience

Developer - Habitat for Humanity of Hobbs, New Mexico Area

Habitat for Humanity is a global nonprofit housing organization working in local communities across all fifty states in the U.S. and in approximately seventy countries. Habitat's vision is of a world where everyone has a decent place to live.

Habitat works toward our vision by building strength, stability, and self-reliance in partnership with families in need of decent and affordable housing. Habitat homeowners help build their own homes alongside volunteers and pay an affordable mortgage.

Habitat for Humanity of Hobbs New Mexico Area was established in Hobbs, NM in 1998, to conduct business as a non-profit corporation in the State of New Mexico. Habitat of Hobbs obtained tax exempt status in 1999 when they were granted affiliate status by Habitat for Humanity International (HfHI). Habitat of Hobbs completed their first home in July of 2000. Our Habitat has built fifty-one homes and has rehabilitated three since its inception. We are currently working on homes 52-59. Habitat for Humanity of Hobbs primarily focuses on new residential construction for low-income families.

Habitat for Humanity of Hobbs has the capacity and capability to build low this RV park in compliance with City Building Codes and all City Development Regulations and policies; and ability to perform this work project in a timely manner.

Pettigrew and Associates had the lowest bid and will be the engineering group we will hire for the design, testing, and certification process. This design process was not done without the input of City of Hobbs personnel, especially Kevin Robinson and Todd Randall.

The Executive Director of Habitat for Humanity of Hobbs, NM Area will be responsible for the making sure Habitat, as the grantee complies with all applicable federal and state laws, rules, and regulations pertaining to this project.

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PROPOSAL FOR A RV PARK FOR VOLUNTEERS

Our mission

Seeking to put God's love into action, Habitat for Humanity brings people together to build homes, communities, and hope.

Our vision

A world where everyone has a decent place to live.

Our principles

- 1. Demonstrate the love of Jesus Christ.
- 2. Focus on shelter.
- 3. Advocate for affordable housing.
- 4. Promote dignity and hope.
- 5. Support sustainable and transformative development.

Non-proselytizing policy

Habitat for Humanity and its affiliate organizations will not proselytize. Nor will Habitat work with entities or individuals who insist on proselytizing as part of their work with Habitat. This means that Habitat will not offer assistance on the expressed or implied condition that people must adhere to or convert to a particular faith or listen and respond to messaging designed to induce conversion to a particular faith.

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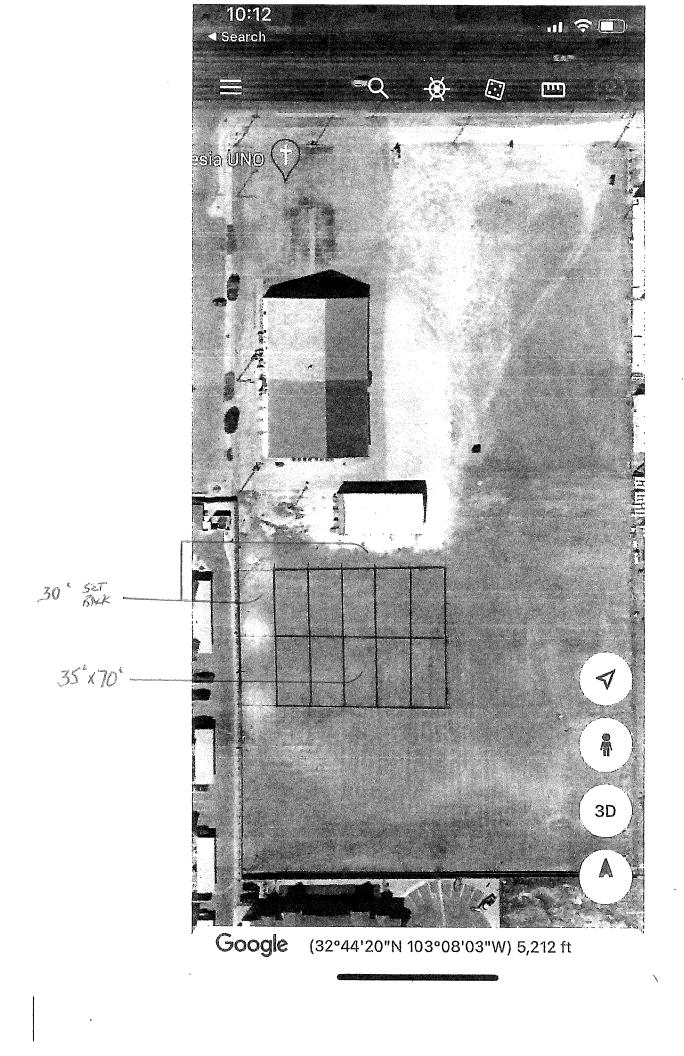
PROPOSAL FOR A RV PARK FOR VOLUNTEERS

All information provided is true and correct to the best of the applicant's information, knowledge, and belief.

Jared Sloan

Habitat for Humanity of Hobbs, New Mexico Area

Board President



PLANNING BOARD



200 E. Broadway St. Hobbs, NM 88240

575-397-9351 bus 575- 397-9227 fax

August 1, 2022

RE: **REQUEST TO AMEND THE PLANNING DISTRICT MAP -- SPECIAL USE PERMIT PROPOSED ALLOWING A RECREATIONAL VEHICLE** PARK TO BE LOCATED AT 301 E. NAVAJO.

Dear Property Owner:


The City of Hobbs has received a request to amend the Planning District Map and issue a special use permit to allow a proposed Mobile Home Park on the 6.7 +/- acre parcel located at 301 E. Navajo (see attached map). As a property owner you are being notified of the developer's intent to construct a Recreation Vehicle Park on the aforementioned parcel. The City Planning Board will be reviewing this issue on August 16, 2022, on the first floor of the City Annex Building at 200 E. Broadway, at 10:00 a.m., in the City of Hobbs Commission Chambers. This notice is being sent to you as a property owner within the notification boundaries per Municipal Code 18.04, requiring notification of district map amendments and special use permits.


If you have questions, or comments, please notify the City Planning Division at the above address, or call the office at (575)397-9232.

Sincerely,

THE CITY OF HOBBS, NEW MEXICO

Kevin Robinson – Planning Department

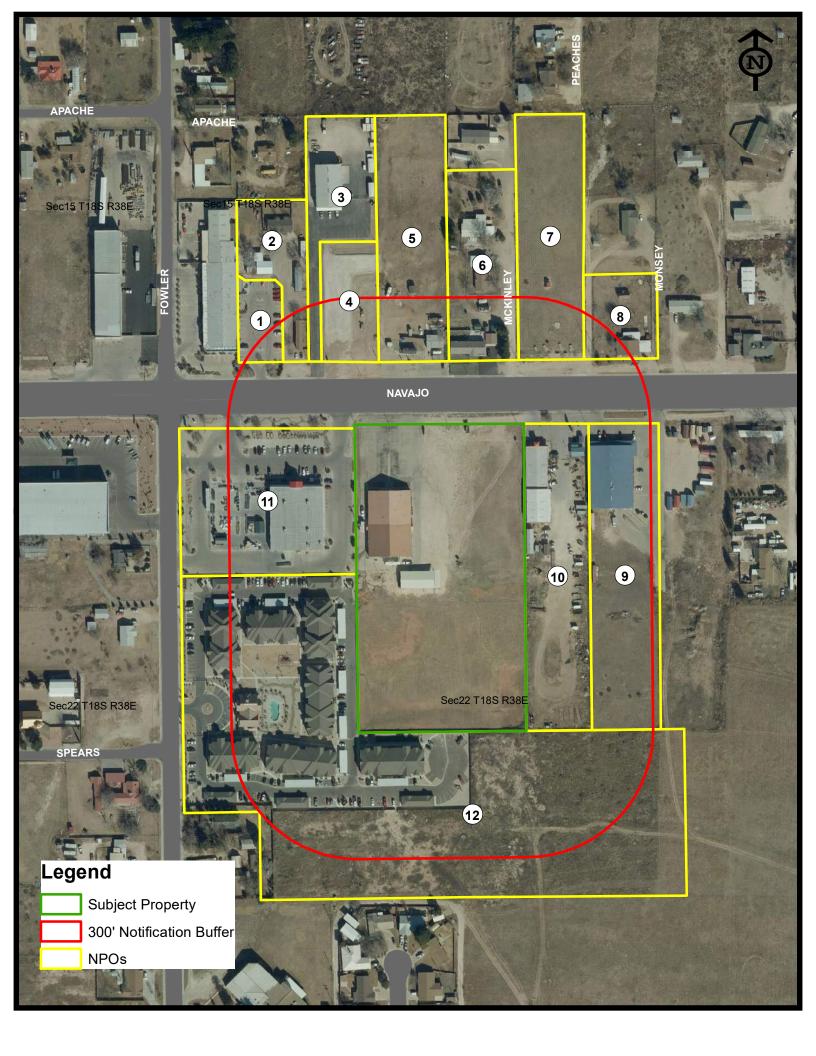

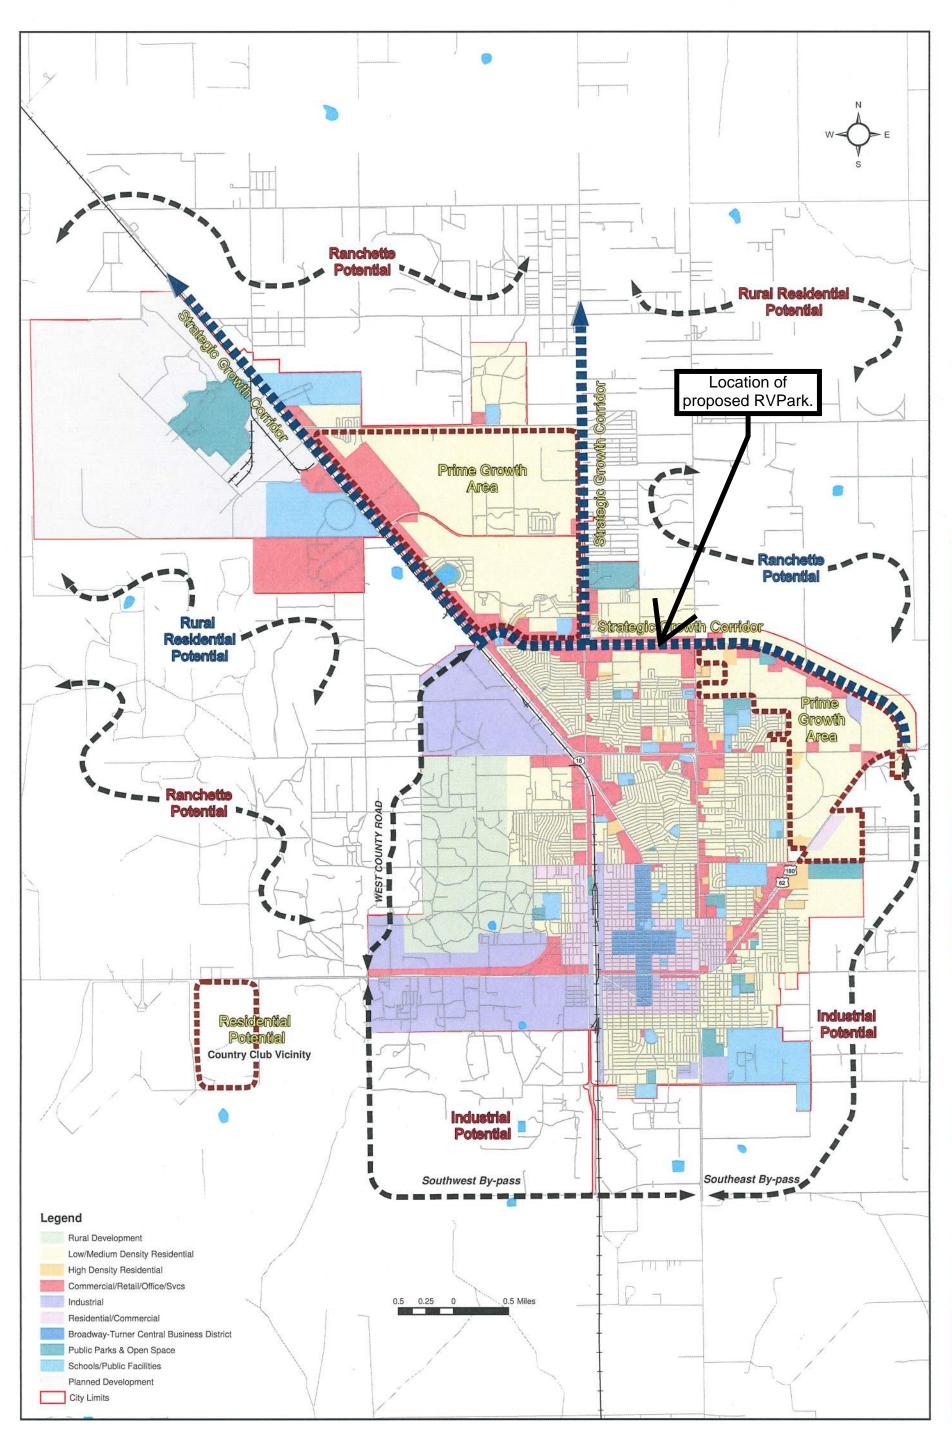

Urban Growth Map



PLANNING BOARD



200 E. Broadway St. Hobbs, NM 88240 575-397-9351 bus 575- 397-9227 fax

City of Hobbs, New Mexico

Planning District Map Amendment Planning Board Report Per MC 18.04.050

Applicant Name: Habitat for Humanity Applicant Address:301 E. Navajo Applicant Phone #:1-575-390-5475 Description\Location of Map Amendment: 301 E. Navajo Proposed Usage: □ Mobile Home Park ☑ Recreational Vehicle Park □ Mobile Home Subdivision

WHEREAS, the Applicant above has submitted to the City of Hobbs Planning Board for approval a Map Amendment of the Official Planning District Map as per MC 18.04.050; and

WHEREAS, at the Public Hearing duly conducted the City of Hobbs Planning Board considered the application, relevant supporting materials, any and all materials and comments submitted by the public and all relevant criteria as per MC 18.04.050 – B.

NOW, Therefore the City of Hobbs Planning Board by a majority vote of its members does hereby \Box APPROVE \Box DENY the Map Amendment as so requested based on the following findings:

- The Map Amendment □ DOES □ DOES NOT foster implementation of the City's Comprehensive Plan; and\or
- 2. The Map Amendment □ IS □ IS NOT different from surrounding land and could function as a transitional use between neighborhoods.

All development if herein authorized must be duly permitted and compliant to City of Hobbs Design Standards as per MC 18.04.060.

City of Hobbs Planning Board William "Tres" Hicks, III, Chairman

18.04.050 Special use permit approval procedures for planning district map amendment.

A. Special Use Permit Approval Process for Approval of Map Amendment of the Official Planning District Map (New Planning Districts) for Mobile Home Parks, Recreational Vehicle Parks and/or Mobile Home Subdivision - Application Procedure. An application for an amendment to the official Planning District map may be initiated by a property owner filing a complete application with the Planning Division in a form established by the City. The application shall include the following information:

Name, address and telephone number of applicant and owner;

Legal description of the property that is the subject of the proposed amendment; A statement of the reasons why the amendment is being requested; and

Other information or documentation necessary to process the application, as required by the Planning Division. The property owner must sign the application for the planning district boundary change. Compliance with such information is necessary to place the application on the Planning Board agenda. The City Planning Division or Planning Board may require an applicant for map amendments to submit such technical studies as may be necessary to enable the proper evaluation of the application. Required studies may include, but are not limited to, traffic studies, engineering studies, noise studies or neighborhood and/or economic impact reports.

B. *Planning Board Review, Public Hearing and Decision Making Process.* The Planning Board shall, after due notice herein, conduct a public hearing on the proposed <u>map amendment</u>. At the public hearing the Planning Board shall consider the application, the relevant supporting materials, and all comments and written materials submitted by the public at the public hearing.

The Planning Board may give consideration to the following criteria, to the extent pertinent to the application. In addition, other factors may be considered which may be relevant to the application.

Conformance of the proposed map amendment with the City's land use policies contained in the adopted Comprehensive Plan.

The character of the neighborhood.

The adjacent residential areas, nearby properties, and the extent to which the proposed new residential development of a MHP or RVP would be compatible.

The extent to which the proposed use would affect the capacity or safety of that portion of the street network, other public facilities or utilities, or existing parking problems in the vicinity of the property.

The extent to which approval of the application would diminish the character of the neighborhood.

The possibility that an error was made when the existing planning district map was created.

C. If approved, the Planning Board must find that the map amendment must foster implementation of the City's adopted Comprehensive Plan; or the area of the proposed change is different from surrounding land

because it could function as a transition between adjacent neighborhood areas.

D. After the public hearing, the Planning Board shall adopt and transmit a final decision report to the applicant. The concurring vote of a simple majority of all current members of the Planning Board (four (4) of six (6) members) is necessary to approve any map amendment. The decision report for applications denied by the Planning Board shall state the reasons why the Planning Board denied the application. The decision of the Planning Board is final unless the applicant or any aggrieved party files a written appeal to the City Clerk within fifteen (15) days of the date of the meeting of the Planning Board when the action occurred. A reapplication for a map change request on the same property may not be considered within two (2) years of the date of final action on the prior application.


E. *Conditional Stipulations Permitted.* In the exercise of its powers to review and approve map amendments, variance and other provisions of this chapter, the Planning Board is authorized to make a conditional approval of a map amendment or a variance, and to place any reasonable conditions on an application in the standard course of approving the map amendment or variance.

F. *Public Notice of Proposed Actions.* Public notice of hearings held before the Planning Board, unless otherwise required by law, shall be given as provided in this section.

- 1. *Published General Notice*. On or before the fifteenth day before the date of any public hearing involving the establishment or amendment of any district boundary, consideration of a special use permit, or a proposed variance from any planning regulation, the Planning Division shall publish in the local newspaper of general circulation in the City of Hobbs a public notice stating the date, time and place of the public hearing at which all parties in interest and citizens shall have an opportunity to be heard. The notice shall include a short description of the proposed action, the subject property and how additional information can be obtained.
- 2. *Mailed Notices.* Whenever a planning district map amendment special use permit is proposed for an area, the Planning Division shall mail notice of the public hearing by certified mail, return receipt requested, to the owners, as shown by the records of the county treasurer, of lots of land within the area proposed to be changed by a map amendment special use permit and to all other owners within the greater of two hundred (200) feet of the subject area, or one hundred (100) feet, excluding public right-of-way, of the subject area. The mailing shall be posted on or before the fifteenth day before the date of the public hearing.
- 3. *Notice of Proposed Variances.* Whenever a variance from the regulations herein are proposed on a property, the Planning Division shall follow the same legal notice and mail notice procedures as noted above for a map amendment public hearing.
- 4. *Posting of Notice Signs.* Public notice of required public hearings on property owner applications for a planning district map amendment special use permit application shall also be provided by way of a sign posted at least ten (10) days before the date of the public hearing on the property that is the subject of the application. One (1) sign shall be posted by the Planning Division for each five hundred (500) feet of frontage along a public street, with a maximum of three (3) signs required per frontage. Signs shall be located so that each sign is clearly visible from the street, or visible from the nearest public street.

August 16, 2021 Planning Board Regular Meeting

4) Review and Consider the Vacation of a portion of Roxanna Street, Skelly Street and the east\west alleyways within Block 31, 44 and 47 of the Humble City Subdivision located within the City of Hobbs ETJ.

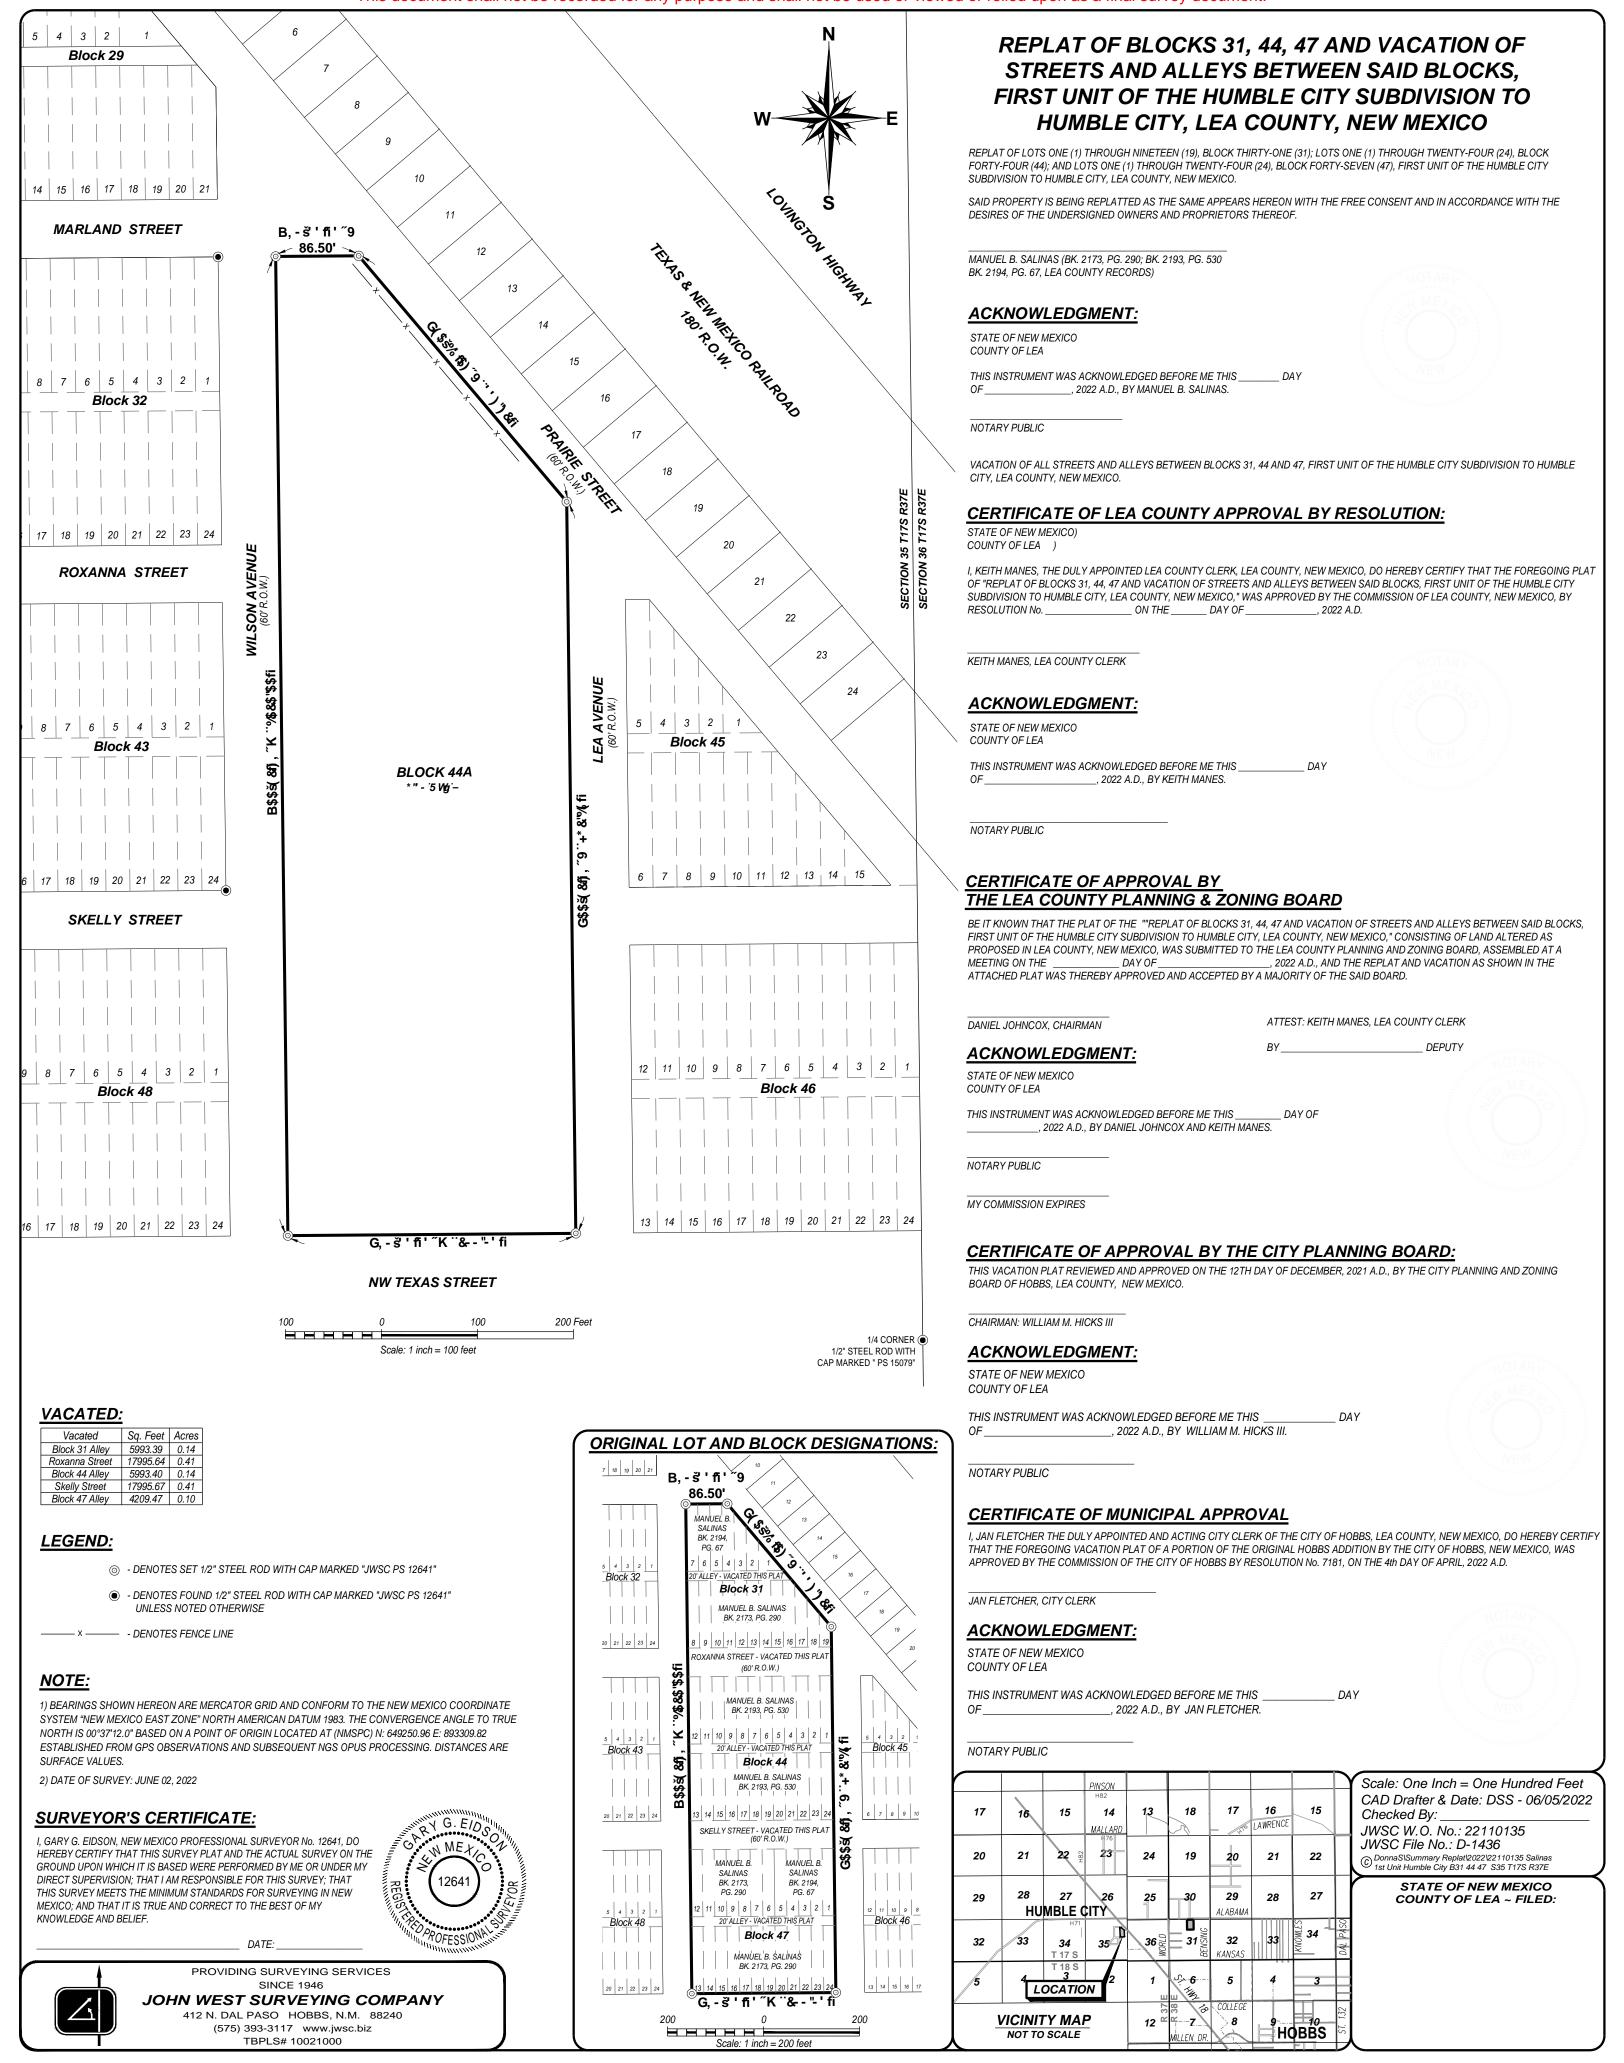




August 16, 2021 Planning Board Regular Meeting

5) Review and Consider Preliminary Plan for The Subdivision of Lots 3, 4, 11 and 12, Block 1 of the Azotea Subdivision, as submitted by property owner, Host, LLC.

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2	DESIGNED:	RJF						
) J								
0	DRAWN:	JB						
	CHECKED:	RJF						
1	APPROVED:							
-	/		NO.	DATE	BY	REVISION		

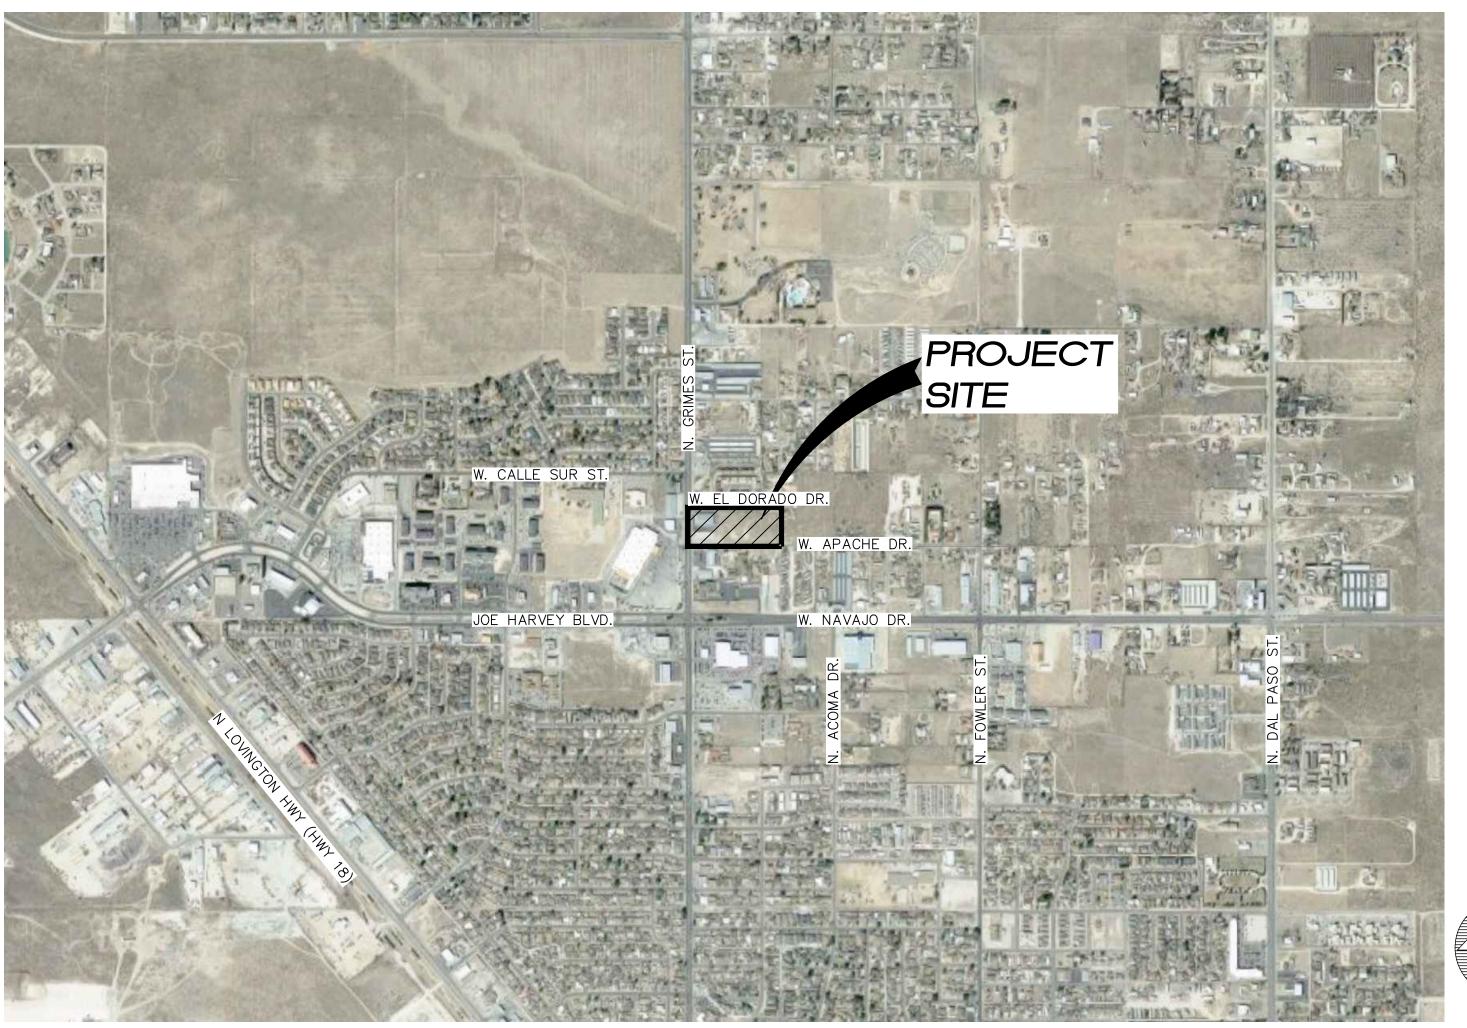		INDEX OF DRAWINGS
SHEET NO.	DWG.	SHEET
1	1-1	COVER SHEET
2	1-2	GENERAL NOTES
3	1-3	GENERAL NOTES
4	2-1	PRELIMINARY SURVEY PLAT
5	2-2	PRELIMINARY SURVEY PLAT
6	3-1	TYPICAL ROADWAY SECTIONS
7	3-2	XCEL ELECTRICAL LAYOUT
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11	5-0	OVERALL UTILITY PLAN
12	5-1	EL DORADO UTILITY PLAN
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CONSTRUCTION PLANS FOR AZOTEA SUBDIVISION TRUCTURE IMPROVEMENTS HOBBS, NEW MEXICO

VICINITY MAP



CLIENT:

THE PECULIAR PEOPLE, LLC

AZOTEA SUBDIVISION	SHEET	1 of 13
INFRASTRUCTURE IMPROVEMENTS	SET	1-1
COVER	DATE	Jul-2022
COVER	PROJ	22047



ALL IMPROVEMENTS, UNLESS OTHERWISE MODIFIED IN THE PROJECT SPECIFICATIONS, SHALL BE CONSTRUCTED IN ACCORDANCE WITH THE APWA NEW MEXICO STANDARD SPECIFICATIONS FOR PUBLIC WORKS CONSTRUCTION, LATEST EDITION, EXCEPT WHERE OTHERWISE NOTED IN THE DRAWINGS.

2. STANDARD DRAWINGS: REFER TO STANDARD DRAWINGS FOR THE NEW MEXICO STANDARD SPECIFICATIONS FOR PUBLIC WORKS CONSTRUCTION, LATEST EDITION UNLESS OTHERWISE NOTED.

THE CONTRACTOR AGREES THAT HE/SHE SHALL ASSUME THE SOLE AND COMPLETE RESPONSIBILITY FOR THE JOB SITE CONDITIONS DURING THE COURSE OF PROJECT CONSTRUCTION, INCLUDING SAFETY OF ALL PERSONS AND PROPERTY, THAT THIS REQUIREMENT SHALL APPLY CONTINUOUSLY AND NOT BE LIMITED TO NORMAL WORKING HOURS, AND THE CONTRACTOR SHALL DEFEND. INDEMNIFY AND HOLD THE OWNER AND ENGINEER HARMLESS FROM ANY AND ALL LIABILITY, REAL OR ALLEGED, IN CONNECTION WITH THE PERFORMANCE OF WORK ON THIS PROJECT, EXCEPTING FOR LIABILITY ARISING FROM THE SOLE NEGLIGENCE OF THE OWNER OR ENGINEER.

4. NO CHANGES SHALL BE MADE TO THESE PLANS WITHOUT THE WRITTEN APPROVAL OF THE OWNER, ENGINEER AND ALL APPROVAL SIGNATORIES. THE ENGINEER SHALL NOT BE RESPONSIBLE FOR CONSTRUCTION METHODS OR TECHNIQUES OR FOR THE PROSECUTION OF THE WORK AS SHOWN ON THESE PLANS. THE ENGINEER SHALL NOT BE RESPONSIBLE FOR THE ACTS OR OMISSIONS OF THE CONTRACTOR, SUBCONTRACTORS OR OTHER PERSONS PERFORMING ANY OF THE WORK OR FOR THE FAILURE OF ANY OF THEM TO CARRY OUT THE WORK IN ACCORDANCE WITH CONTRACT DOCUMENTS.

5. UNLESS OTHERWISE PROVIDED AS PART OF THE CONSTRUCTION PLANS, A COMPLETE TRAFFIC CONTROL PLAN SHALL BE PREPARED BY THE CONTRACTOR WHEN ANY PORTION OF THE WORK IS IN THE PUBLIC RIGHT-OF-WAY OR AFFECTING ON-SITE VEHICLE OR PEDESTRIAN CIRCULATION. ALL CONSTRUCTION SIGNING, BARRICADING AND CHANNELIZATION SHALL CONFORM TO THE MANUAL ON UNIFORM TRAFFIC CONTROL DEVICES (MUTCD) LATEST EDITION. THE PLAN SHALL BE SUBMITTED TO THE ENGINEER FOR APPROVAL FOR ON-SITE CONSTRUCTION. TRAFFIC CONTROL WITHIN THE CITY/COUNTY RIGHT-OF-WAY SHALL DEFAULT TO THE CITY/COUNTY TRAFFIC DEPARTMENT FOR APPROVAL. THE CONTRACTOR SHALL NOT IMPLEMENT THE TRAFFIC CONTROL PLAN UNTIL APPROVAL OF THE PLAN HAS BEEN RECEIVED FROM THE ENGINEER. THE TRAFFIC CONTROL PLAN SHALL BE SUBMITTED TO AND APPROVED BY THE CITY OR ENGINEER.

6. THE CONTRACTOR SHALL DESIGNATE AT LEAST ONE EMERGENCY CONTACT PERSON, AND SHALL PROVIDE TELEPHONE NUMBERS WHERE THIS PERSON CAN BE CONTACTED AT ANY TIME. INCLUDING WEEKENDS, HOLIDAYS AND AFTER HOURS. THIS INFORMATION SHALL BE PROVIDED TO THE OWNER AND THE ENGINEER.

7. THE CONTRACTOR IS RESPONSIBLE FOR OBTAINING ALL REQUIRED CONSTRUCTION PERMITS FROM ALL JURISDICTIONAL AUTHORITIES PRIOR TO START OF CONSTRUCTION. PERMIT COSTS ARE INCIDENTAL TO BASE BID.

8. ALL WORK ON THIS PROJECT SHALL BE PERFORMED IN ACCORDANCE WITH APPLICABLE FEDERAL, STATE AND LOCAL LAWS, RULES AND REGULATIONS CONCERNING CONSTRUCTION SAFETY, HEALTH, AND ENVIRONMENTAL PROTECTION.

9. EXISTING SITE IMPROVEMENTS WHICH ARE DAMAGED OR DISPLACED BY THE CONTRACTOR SHALL BE REMOVED AND REPLACED BY THE CONTRACTOR AT THE CONTRACTOR'S OWN EXPENSE. REPAIRS SHALL BE APPROVED BY THE OWNER PRIOR TO CONSTRUCTION OF THE REPAIRS. REPAIRS SHALL BE ACCEPTED BY THE OWNER PRIOR TO FINAL PAYMENT.

10. THE CONTRACTOR SHALL USE THE DESIGNATED STAGING AREAS FOR STORAGE OF EQUIPMENT AND MATERIAL. NO MATERIAL OR EQUIPMENT MAY BE STORED OR LEFT ON-SITE AT ANY OTHER LOCATION. THE OWNER ASSUMES NO LIABILITY FOR CONTRACTOR'S EQUIPMENT AND MATERIAL IN THE STAGING AREA. SECURITY SHALL BE THE RESPONSIBILITY OF THE CONTRACTOR. IF NO STAGING AREA IS DESIGNATED ON THESE PLANS, AN OFF-SITE STAGING AREA SHALL BE PROVIDED AT THE CONTRACTOR'S EXPENSE, OR THE CONTRACTOR MAY NEGOTIATE WITH THE OWNER TO USE AN ON-SITE AREA. OWNER WILL HAVE A STAGING AREA DESIGNATED.

11. ALL STATIONING REFERS TO THE CENTERLINE OF THE RIGHT-OF-WAY UNLESS OTHERWISE NOTED. STATIONING OF CHANNELS OR PIPES IN DRAINAGE EASEMENTS REFERS TO THE CENTERLINE OF CHANNEL OR PIPE, UNLESS OTHERWISE NOTED.

12. THE CONTRACTOR SHALL BE RESPONSIBLE FOR DETERMINING, IN ADVANCE OF THEIR CONSTRUCTION OPERATIONS, IF OVERHEAD UTILITY LINES, SUPPORT STRUCTURES, POLES, GUYS, ETC., ARE AN OBSTRUCTION TO CONSTRUCTION OPERATIONS. IF ANY OBSTRUCTION IS EVIDENT, THE CONTRACTOR SHALL BE RESPONSIBLE FOR COORDINATING WITH THE APPROPRIATE UTILITY OWNER TO REMOVE OR SUPPORT THE UTILITY OBSTRUCTION. ALL COSTS FOR THESE REQUIREMENTS ARE INCIDENTAL TO THE CONTRACT.

13. FACILITIES WHICH ARE NOT SPECIFICALLY LOCATED WITH ACTUAL VERTICAL AND HORIZONTAL CONTROLS ON THE CONSTRUCTION DOCUMENTS, ARE SHOWN APPROXIMATE AND IN ACCORDANCE WITH THE BEST AVAILABLE INFORMATION PROVIDED BY VARIOUS OWNERS OF THE FACILITIES, AND SUPPLEMENTED BY VISUAL SURFACE INFORMATION WHERE APPROPRIATE. ACCURACY, LOCATION, AND COMPLETENESS OF THIS INFORMATION IS THE SOLE RESPONSIBILITY OF THE CONTRACTOR AND SHOULD BE VERIFIED, BY ANY MEANS NECESSARY, BEFORE THE INITIATION OF CONSTRUCTION. SHOULD A CONFLICT EXIST, THE CONTRACTOR SHALL NOTIFY THE CITY, ENGINEER, AND THE CITY'S PROJECT MANAGER IMMEDIATELY.

14. IT IS MANDATORY THAT A PRECONSTRUCTION MEETING BE HELD BEFORE COMMENCING CONSTRUCTION. THE CONTRACTOR IS RESPONSIBLE FOR CONTACTING THE CITY'S PROJECT MANAGER TO DETERMINE THE TIME AND LOCATION OF THE PRECONSTRUCTION MEETING.

15. <u>AS-BUILTS:</u> CONTRACTOR SHALL DELIVER FINAL CERTIFIED AS-BUILTS IN HARD COPY. AS-BUILTS SHALL BE SUBMITTED WITH SUBSTANTIAL COMPLETION PAY APPLICATION. NO PAYMENT WILL BE MADE WITHOUT AS-BUILT SUBMITTAL.

16. CALL NM811 AT LEAST 2-DAYS BEFORE DIGGING.

17. THE CONTRACTOR SHALL CONFINE THEIR WORK TO WITHIN THE CONSTRUCTION LIMITS AND/OR PUBLIC RIGHT-OF-WAY TO PRESERVE EXISTING VEGETATION, LANDSCAPING, AND PRIVATE PROPERTY. APPROVAL OF THESE PLANS DOES NOT GIVE OR IMPLY ANY PERMISSION TO TRESPASS OR WORK ON PRIVATE PROPERTY. PERMISSION MUST BE GRANTED IN WRITING BY THE OWNER OF THAT PROPERTY.

EROSION CONTROL/ENVIRONMENTAL PROTECTION/STORM WATER POLLUTION PREVENTION PLAN

THE CONTRACTOR SHALL BE RESPONSIBLE FOR FULFILLING ALL NECESSARY NATIONAL POLLUTANT DISCHARGE ELIMINATION SYSTEM (NPDES) REQUIREMENTS INCLUDING, BUT NOT LIMITED TO, OBTAINING AN NPDES PERMIT BEFORE CONSTRUCTION, FILLING OUT THE NOTICE OF INTENT (NOI) APPLICATION, AND FILLING OUT THE NOTICE OF TERMINATION (NOT) APPLICATION. THE CONTRACTOR SHALL ALSO BE RESPONSIBLE FOR THE IMPLEMENTATION OF AND INSPECTION REPORTS FOR THE STORM WATER POLLUTION PREVENTION PLAN (SWPPP). THE CONTRACTOR SHALL SUBMIT THE SWPPP WITH THE PROPOSED CONSTRUCTION STAGING AREA AND TEMPORARY SANITARY FACILITIES CLEARLY SHOWN. ANY CHECK DAMS, SILT FENCES, OR OTHER BEST MANAGEMENT PRACTICES (BMP) THAT ARE REQUIRED IN THE APPROVED SWPPP SHALL BE INCLUDED IN AND ARE INCIDENTAL TO THE SWPPP BID AMOUNT.

THE CONTRACTOR IS REQUIRED TO KEEP A CURRENT COPY OF THE SWPPP AT THE CONSTRUCTION SITE LOCAL ORDINANCES, RULES AND REGULATIONS, IF ANY, PERTAINING TO THE LOCATION OF OR AT AN EASILY ACCESSIBLE LOCATION SO THAT IT CAN BE MADE AVAILABLE AT THE TIME OF AN ONSITE THESE LINES AND FACILITIES. INSPECTION OR UPON REQUEST BY THE EPA; A STATE, TRIBAL, OR LOCAL AGENCY APPROVING STORM WATER MANAGEMENT PLANS; THE OPERATOR OF A STORM SEWER SYSTEM RECEIVING DISCHARGES FROM THE SITE; OR THE CONTRACTOR SHALL NOTIFY NEW MEXICO ONE CALL, INC. AT PHONE NO. (811) REPRESENTATIVES OF THE U.S. FISH AND WILDLIFE SERVICE (USFWS) OR THE NATIONAL MARINE FISHERIES LEAST TWO WORKING DAYS PRIOR TO STARTING WORK ON THIS PROJECT. SERVICE (NMFS).

THE CONTRACTOR SHALL CONFORM TO ALL CITY, COUNTY, STATE AND FEDERAL DUST AND EROSION CONTROL REGULATIONS. THE CONTRACTOR SHALL PREPARE AND OBTAIN ANY NECESSARY DUST OR EROSION CONTROL PERMITS FROM THE REGULATORY AGENCIES.

4. THE CONTRACTOR SHALL EITHER PROMPTLY REMOVE ANY MATERIAL EXCAVATED WITHIN THE PUBLIC RIGHT-OF-WAY OR INSTALL BMPS ACCORDING TO NPDES REQUIREMENTS TO PREVENT DISCHARGE OF EXCAVATED MATERIAL WITHIN THE PUBLIC RIGHT-OF-WAY DURING A RAIN OR WIND EVENT. ALL COSTS FOR THESE REQUIREMENTS ARE INCIDENTAL TO THE CONTRACT.

THE CONTRACTOR SHALL IMPLEMENT THE APPROVED SWPPP AND ENSURE THAT NO SOIL ERODES FROM THE SITE INTO PUBLIC RIGHT-OF-WAY OR ONTO PRIVATE PROPERTY.

THE CONTRACTOR SHALL MITIGATE EROSION OF TEMPORARY OR PERMANENT DIRT SWALES BY INSTALLING BMPS IDENTIFIED IN THE APPROVED SWPPP IN THE SWALES PERPENDICULAR TO THE DIRECTION OF FLOW, AND AT INTERVALS AS SPECIFIED IN THE SWPPP.

THE CONTRACTOR MUST OBTAIN WRITTEN APPROVAL FROM THE CITY OF HOBBS WA CONSTRUCTION AREAS SHALL BE WATERED FOR DUST CONTROL IN COMPLIANCE WITH GOVERNMENT DEPT. TO OPERATE ANY VALVE OR FIRE HYDRANT INCLUDING NEW WATERLINES AND EXT ORDINANCES. THE CONTRACTOR SHALL BE RESPONSIBLE FOR LOCATING AND SUPPLYING WATER AS REQUIRED. TO THE WATER SYSTEM WHICH HAVE NOT YET BEEN ACCEPTED BY ARE CONNECTED TO WATERING, AS REQUIRED FOR CONSTRUCTION AND DUST CONTROL, SHALL BE CONSIDERED INCIDENTAL TO EXISTING WATER SYSTEM. ONCE APPROVAL HAS BEEN VERIFIED, THE CONTRACTOR MUST CONSTRUCTION AND NO MEASUREMENT OR PAYMENT SHALL BE MADE THEREFORE. CONTACT THE CITY OF HOBBS WATER DEPT., 48 HOURS IN ADVANCE TO REQUEST A SHI 8. ANY AREAS DISTURBED BY CONSTRUCTION AND NOT COVERED BY LANDSCAPING OR AN IMPERVIOUS DATE. WATER SHUT OFF MAY BE DONE AT NIGHT OR ON WEEKENDS TO ACCOMMODATE \

SURFACE SHALL BE RE-VEGETATED WITH NATIVE GRASS SEEDING. WHEN CONSTRUCTION ACTIVITIES CEASE AND CUSTOMERS. EARTH DISTURBING ACTIVITIES WILL NOT RESUME WITHIN 14 DAYS, STABILIZATION MEASURES MUST BE WATER LINES SHALL BE CONSTRUCTED WITH A MINIMUM OF 3.0 FT. COVER MEASUR INITIATED. UNLESS INDICATED OTHERWISE ON THESE PLANS OR ON THE LANDSCAPING PLAN, NATIVE GRASS FROM FINISH GRADE TO THE TOP OF PIPE, UNLESS OTHERWISE SPECIFIED ON PLANS. SEEDING SHALL BE IN ACCORDANCE WITH SECTION 1012 OF THE NEW MEXICO STANDARD SPECIFICATIONS FOR PUBLIC WORKS CONSTRUCTION, APWA NM CHAPTER, CURRENT EDITION.

FOR PRESSURE WATER CONNECTIONS TO EXISTING LINES, THE CONTRACTOR SHALL COORDINATE WITH THE CITY OF HOBBS. CITY OF HOBBS PERFORMS PRESSURE WATER 9. ALL WASTE PRODUCTS FROM THE CONSTRUCTION SITE, INCLUDING ITEMS DESIGNATED FOR REMOVAL, CONNECTIONS. CONTACT SEVERAL WEEKS IN ADVANCED TO SCHEDULE PRESSURE WATER CONSTRUCTION WASTE, CONSTRUCTION EQUIPMENT WASTE PRODUCTS (OIL, GAS, TIRES, ETC.) GARBAGE, CONNECTIONS. GRUBBING, EXCESS CUT MATERIAL, VEGETATIVE DEBRIS, ETC. SHALL BE APPROPRIATELY DISPOSED OF OFFSITE AT NO ADDITIONAL COST TO THE CITY. IT SHALL BE THE CONTRACTOR'S RESPONSIBILITY TO OBTAIN PERMITS CONCRETE THRUST BLOCKS SHALL BE USED ON ALL 90 DEGREE BENDS, TEES TO REQUIRED TO HAUL OR DISPOSE OF WASTE PRODUCTS. IT SHALL BE THE CONTRACTOR'S RESPONSIBILITY TO HYDRANTS, BEHIND HYDRANTS AND UNDER VALVES. ALL FITTINGS AND CAPS SHALL USE ENSURE THAT THE WASTE DISPOSAL SITE COMPLIES WITH GOVERNMENT REGULATIONS REGARDING THE LUG RESTRAINTS. NO EXTRA PAYMENT WILL BE MADE FOR THESE FEATURES. ENVIRONMENT, ENDANGERED SPECIES, AND ARCHAEOLOGICAL RESOURCES.

COMPRESSION JOINTS MAY BE USED ON COPPER SERVICE LINES EXCEPT FLARED JO 10. THE CONTRACTOR SHALL BE RESPONSIBLE FOR THE CLEANUP AND REPORTING OF SPILLS OF HAZARDOUS SHALL BE USED WHEN CONNECTING TO PLASTIC LINES. MATERIALS ASSOCIATED WITH THE CONSTRUCTION SITE. HAZARDOUS MATERIALS INCLUDE GASOLINE, DIESEL FUEL, MOTOR OIL, SOLVENTS, CHEMICALS, PAINTS, ETC. WHICH MAY BE A THREAT TO THE ENVIRONMENT. THE THE 24" DEPTH OF SERVICE LINE BELOW FINISH SURFACE ELEVATION OF METER BOX CONTRACTOR SHALL REPORT THE DISCOVERY OF PAST OR PRESENT SPILLS TO THE NEW MEXICO ENVIRONMENT CRITICAL. METERS WILL NOT BE INSTALLED WHEN THIS DIMENSION VARIES. DEPARTMENT EMERGENCY RESPONSE TEAM AT (505) 827-9329.

VALVE BOXES SHALL BE BROUGHT TO SURFACE ELEVATION UPON COMPLETION OF 11. THE CONTRACTOR SHALL COMPLY WITH ALL APPLICABLE REGULATIONS CONCERNING SURFACE AND SURFACE COURSE OF PAVEMENT. UNDERGROUND WATER. CONTACT WITH SURFACE WATER BY CONSTRUCTION EQUIPMENT AND PERSONNEL SHALL BE MINIMIZED. EQUIPMENT MAINTENANCE AND REFUELING OPERATIONS SHALL BE PERFORMED IN AN ALL PIPING, VALVES, FITTINGS, AND SERVICES UTILIZE FOR POTABLE WATER SERVIC ENVIRONMENTALLY SAFE MANNER IN COMPLIANCE WITH GOVERNMENT REGULATIONS.

12. WHERE STORM INLETS ARE SUSCEPTIBLE TO INFLOW OF SILT OR DEBRIS FROM CONSTRUCTION ACTIVITIES, PROTECTION SHALL BE PROVIDED ON THEIR UPSTREAM SIDE UTILIZING BMPS ACCORDING TO NPDES REQUIREMENTS. ALL COSTS FOR THESE REQUIREMENTS ARE INCIDENTAL TO THE CONTRACT.

13. STORM WATER POLLUTION PREVENTION PLANS (SWPPP) AND ACCOMPANYING FEDERAL EPA ADMINISTRATIVE PROCEDURES SHALL MEET THE CITY OF HOBBS GUIDELINES AND PROCEDURES OUTLINED IN THE CURRENT ADDITION OF THE NEW MEXICO STATE HIGHWAY AND TRANSPORTATION DEPARTMENT STORM WATER MANAGEMENT GUIDELINES FOR CONSTRUCTION AND INDUSTRIAL ACTIVITIES MANUAL.

14. THE CONTRACTOR SHALL PROVIDE ADEQUATE MEANS FOR CLEANING TRUCKS AND/OR OTHER EQUIPMENT OF MUD BEFORE ENTERING PUBLIC STREETS. IT IS THE CONTRACTOR'S RESPONSIBILITY TO CLEAN STREETS AND TAKE WHATEVER MEASURES ARE NECESSARY TO ENSURE THAT ALL ROADS ARE MAINTAINED IN A CLEAN, MUD AND DUST-FREE CONDITION AT ALL TIMES.

ROADWAY GENERAL NOTES

1. NO PAVING CONSTRUCTION ACTIVITIES SHALL BE STARTED UNTIL ALL UNDERGROUND UTILITIES WITHIN THE ROADWAY ARE COMPLETED, TESTED, AND APPROVED. ALL WATER VALVE BOXES AND ELECTRICAL, TELEPHONE, 13. 4" PVC WATERLINE SHALL BE CLASS C900 DR-18. TELEVISION, AND SEWER MANHOLES IN THE CONSTRUCTION AREA SHALL BE ADJUSTED TO FINISHED GRADE.

2. ALL SIGNS, BARRICADES, CHANNELIZATION DEVICES, PAVEMENT MARKINGS, SIGN FRAMES AND ERECTION OF SUCH DEVICES SHALL CONFORM TO THE REQUIREMENTS OF THE "MANUAL ON UNIFORM TRAFFIC CONTROL DEVICES FOR STREETS AND HIGHWAYS" (MUTCD), CURRENT EDITION.

3. ALL STREET STRIPING ALTERED OR DESTROYED DURING CONSTRUCTION SHALL BE REPLACED BY THE CONTRACTOR TO MATCH THE ORIGINAL CONDITIONS (I.E. TYPE, SPACING) AT THE LOCATION PRIOR TO CONSTRUCTION, OR AS SHOWN IN THIS PLAN SET.

4. STREET GRADES SHALL BE RESTORED BY THE CONTRACTOR TO THE EXISTING GRADES UNLESS OTHERWISE DIRECTED BY THE CITY OF HOBBS. SMOOTH TRANSITIONS SHALL BE MADE BETWEEN EXISTING PAVEMENT WHICH REMAINS IN PLACE AND PAVEMENT WHICH IS REPLACED. WHEN ABUTTING NEW PAVEMENT TO EXISTING, SAW CUT BACK EXISTING PAVEMENT TO A NEAT, STRAIGHT LINE AS REQUIRED TO REMOVE ANY BROKEN OR CRACKED PAVEMENT.

5. THE LOCATION OF ALL VALVES AND MANHOLES MUST BE REFERENCED AT ALL TIMES BY THE CONTRACTOR DURING CONSTRUCTION AND MADE ACCESSIBLE DAILY UPON COMPLETION OF ALL PAVING ACTIVITIES.

DESIGNED:	RJF						
DRAWN:	JB						
DRAWN.	JD						
CHECKED:	RJF						
APPROVED:							
		NO.	DATE	BY	REVISION		

UTILITIES-GENERAL NOTE:

1. IF ANY UTILITY LINES, PIPELINES OR UNDERGROUND UTILITY LINES ARE SHOWN ON DRAWINGS. THEY ARE SHOWN IN AN APPROXIMATE LOCATION ONLY, AND LINES MAY EXIS WHERE NONE ARE SHOWN. THE LOCATION IS BASED UPON INFORMATION PROVIDED BY TH UTILITY OWNER OR FROM EXISTING PLANS, AND THIS INFORMATION MAY BE INCOMPLETE, OBSOLETE AT THE TIME OF CONSTRUCTION. THE ENGINEER HAS NOT UNDERTAKEN ANY VERIFICATION OF THESE LOCATIONS, LINE SIZES OR MATERIAL TYPE, MAKES NO REPRESENTATION THERETO, AND ASSUMES NO RESPONSIBILITY ITSELF OF THE LOCATION UTILITY LINE, PIPELINE OR UNDERGROUND INSTALLATION IN OR NEAR THE AREA IN ADVA ANY DURING ANY EXCAVATION WORK. THE CONTRACTOR IS FULLY RESPONSIBLE FOR AN' ALL DAMAGES CAUSED BY ITS FAILURE TO LOCATE, IDENTIFY AND PRESERVE ANY AND EXISTING UTILITIES, PIPELINES AND UNDERGROUND FACILITIES. IN PLANNING AND CONDUC EXCAVATIONS. THE CONTRACTOR SHALL COMPLY WITH ALL STATE STATUES, MUNICIPAL A

3. SEWER/WATER LINES SHALL BE PLACED IN SEPARATE TRENCHES A DISTANCE OF 15 TYPICALLY OR A MINIMUM OF 10 FEET APART HORIZONTALLY. THE WATER LINE SHALL BE PLACED A MINIMUM OF 1.5 FEET HIGHER IN ELEVATION THAN THE SEWER. AT ALL CROS OF WATER AND SEWER LINES, THE WATER LINE SHALL BE MINIMUM OF 1.5 HIGHER THAN SEWER OR THE SEWER LINE SHALL BE SDR 26 PRESSURIZED PIPE. IF THESE REQUIREMENT ARE NOT MET, CONSTRUCT SEWER ENCASEMENT PER APWA STD. DWG. 2140.

SEWER & WATER LINE DISTANCES SHOWN IN PLANS ARE HORIZONTAL DISTANCES WI REGARD TO SLOPE OF PIPE OR PROJECT STATIONING.

ELECTRONIC MARKER DEVICES (EMD) WILL BE REQUIRED AT ALL SANITARY SEWER MANHOLES AND WATER VALVE CANS, NEW OR ADJUSTED TO GRADE THROUGHOUT THE PF EMD'S SHALL BE INCIDENTAL TO ITEM OR ADJUSTMENT.

WATER:

SHALL BE DISINFECTED IN ACCORDANCE WITH NMED REQUIREMENTS. PIPELINES SHALL BE DISINFECTED IN ACCORDANCE WITH AWWA C-651. REFER TO APWA SPECIFICATIONS SECT 801.17.

FLUSHING OF WATER LINES SHALL BE METERED. ORDER OF PREFERENCE FOR DISPOS (1) ON AVAILABLE LAND SURFACE (2) IN STORM SEWERS OR (3) IN SANITARY SEWERS. DIŚPOSAL METHOD SHALL BE DISCUSSED WITH ENGINEER OR THE CITY OF HOBBS WATER DEPARTMENT.

10. FLUSHING, DISINFECTING AND TESTING OF WATERLINES SHALL BE COORDINATED WITH CITY OF HOBBS WATER DEPT.

11. DEFLECTIONS AT PIPE JOINTS AND FITTINGS SHALL BE ACCOMPLISHED IN ACCORDAN WITH PIPE MANUFACTURE'S RECOMMENDED PRACTICES. IN NO CIRCUMSTANCE SHALL ANY DEFLECTION. WHETHER AT A FITTING OR A JOINT. EXCEED THE MANUFACTURERS RECOMMENDATIONS.

12. WHERE ANY SINGLE JOINT DEFLECTION IS SHOWN EXCEEDING 1.5°, CONTRACTOR SH EVENLY DISTRIBUTE TOTAL DEFLECTIONS BETWEEN UPSTREAM AND DOWNSTREAM JOINTS TO ACCOMMODATE TOTAL DEFLECTION REQUIREMENT WITHOUT EXCEEDING THE MANUFACT RECOMMENDATION DEFLECTION AT ANY SINGLE JOINT.



CLIENT:

THE PECULIAR PEOPLE, LLC

E OF	MAXIMUM DENSITY. <u>MATERIALS</u> STRUCTURAL FUL IN THE RUUDING AREA	PERCENT (%) <u>COMPACTION</u> 95	
G	STRUCTURAL FILL IN THE BUILDING AREA SUB BASE FOR SLAB SUPPORT MISCELLANEOUS BACKFILL BELOW STRUCTURAL	95	
	FILL OR ROAD MISCELLANEOUS BACKFILL BELOW UNPAVED,	95	
Т	NON-BUILDING AREAS ROAD SUB GRADE	90 95	
EET	SIDEWALK SUB GRADE CURB AND GUTTER SUBGRADE	95 95	
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GRADING NOTES:

1. EXCEPT AS PROVIDED HEREIN, GRADING SHALL BE PERFORMED AT THE ELEVATIONS AND IN ACCORDANCE WITH THE DETAILS SHOWN ON THIS PLAN.

2. EARTH SLOPES SHALL NOT EXCEED 3 HORIZONTAL TO 1 VERTICAL UNLESS OTHERWISE SHOWN.

3. IT IS THE INTENT OF THESE PLANS THAT THIS CONTRACTOR SHALL NOT PERFORM ANY WORK OUTSIDE OF THE PROPERTY BOUNDARIES EXCEPT AS REQUIRED BY THIS PLAN.

4. A DISPOSAL SITE FOR ANY & ALL EXCESS EXCAVATION MATERIAL AND UNSUITABLE MATERIAL, SHALL BE OBTAINED BY THE CONTRACTOR IN COMPLIANCE WITH APPLICABLE ENVIRONMENTAL REGULATIONS. ALL COSTS INCURRED IN OBTAINING A DISPOSAL SITE AND HAUL FROM THE SITE SHALL BE CONSIDERED INCENTAL TO THE PROJECT AND NO SEPARATE MEASUREMENT OR PAYMENT SHALL BE MADE.

5. A BORROW SITE CONTAINING ACCEPTABLE FILL MATERIAL SHALL BE OBTAINED BY THE CONTRACTOR IN COMPLIANCE WITH APPLICABLE ENVIRONMENTAL REGULATIONS. ALL COSTS INCURRED IN OBTAINING A BORROW SITE AND HAUL TO THE SITE SHALL BE CONSIDERED INCIDENTAL TO THE PROJECT AND NO SEPARATE MEASUREMENT OR PAYMENT SHALL BE MADE.

6. VERIFY ALL ELEVATIONS SHOWN ON PLAN FROM BASIS OF ELEVATION CONTROL STATION PRIOR TO BEGINNING CONSTRUCTION.

7. DENSITY TESTING SHALL BE PER C.O.H. SPECIFICATIONS.

8. ALL AREAS DISTURBED BY THE CONSTRUCTION ACTIVITIES OF THIS PROJECT SHALL BE RESTORED AND RE-GRADED IN A MANNER ACCEPTABLE TO THE OWNER AND ENGINEER. ANY REQUIRED RESTORATION AND RE-GRADING IS CONSIDERED INCIDENTAL TO CONSTRUCTION AND NO EXTRA PAYMENT SHALL BE MADE TO THE CONTRACTOR.

9. UNLESS OTHERWISE SPECIFIED SUBGRADE SOILS AND STRUCTURAL FILL MATERIALS SHALL BE PER THE GEOTECHNICAL REPORT.

10. ALL WORK RELATIVE TO FOUNDATION CONSTRUCTION, SITE PREPARATION, AND PAVEMENT INSTALLATION, AS SHOWN ON THIS PLAN, SHALL BE CONSTRUCTED IN ACCORDANCE WITH THE SOILS REPORT. ALL OTHER WORK, UNLESS OTHERWISE STATED OR PROVIDED FOR HERON, SHALL BE CONSTRUCTED IN ACCORDANCE WITH THE CITY OF HOBBS SPECIFICATIONS (FIRST PRIORITY), AND/OR THE NMAPWA STANDARD SPECIFICATIONS FOR PUBLIC WORKS (SECOND PRIORITY).

11. PRIOR TO GRADING, ALL VEGETATION DEBRIS, AND NEAR SURFACE ORGANICALLY CONTAMINATED SOIL SHALL BE STRIPPED FROM ALL AREAS TO BE GRADED. VEGETATION AND DEBRIS SHALL BE DISPOSED AT A LEGALLY ACCEPTABLE LOCATION.

12. THE CONTRACTOR IS TO ENSURE THAT NO SOIL ERODES FROM THE SITE ONTO ADJACENT PROPERTY OR PUBLIC RIGHT-OF-WAY. THIS SHOULD BE ACHIEVED BY CONSTRUCTING TEMPORARY BERMS AT THE PROPERTY LINES WETTING THE SOIL TO PROTECT IT FROM WIND EROSION AND OTHER MEANS AS DTERMINED BY THE CONTRACTOR.

13. PAVING AND ROADWAY GRADES SHALL BE ± 0.05 ' FROM PLAN ELEVATIONS. PAD ELEVATIONS SHALL BE $\pm /-0.05$ ' FROM BUILDING PLAN ELEVATIONS.

14. ALL SPOT ELEVATIONS ARE TO FLOWLINE UNLESS OTHERWISE NOTED. VALLEY GUTTER ELEVATIONS ARE SHOWN AT FLOWLINE ELEVATION.

15. ALL DISTURBED AREA, INCLUDING SLOPES GRADED AT 3 HORIZONTAL TO 1 VERTICAL SHALL BE RE-SEEDED PER NMAPWA SPECIFICATION 1012.

16. PAD OVER EXCAVATION SHALL BE PER THE GEOTECHNICAL REPORT.

WASTEWATER GENERAL NOTES

1. SEWER/WATER LINES SHALL BE PLACED IN SEPARATE TRENCHES AT A DISTANCE OF 15 FEET TYPICALLY OR A MINIMUM OF 10 FEET APART HORIZONTALLY. THE WATER LINE SHALL BE PLACED A MINIMUM OF 1.5 FEET HIGHER IN ELEVATION THAN THE SEWER LINE. AT ALL CROSSINGS OF WATER AND SEWER LINES, THE WATER LINE SHALL BE A MINIMUM OF 1.5 FEET HIGHER THAN THE SEWER LINE OR THE SEWER LINE SHALL BE C-900 PRESSURIZED PIPE.

2. IT WILL BE THE CONTRACTOR'S SOLE RESPONSIBILITY TO PROTECT AND MAINTAIN IN SERVICE ALL EXISTING UTILITIES. THE CONTRACTOR SHALL ADEQUATELY SUPPORT AND PROTECT EXISTING UTILITIES AFFECTED BY THE CONTRACTOR'S TRENCHING ACTIVITY. IN THE EVENT THAT EXISTING UTILITIES ARE DAMAGED BY THE CONTRACTOR'S OPERATIONS, THE CONTRACTOR SHALL ARRANGE FOR AND COORDINATE WITH THE PROJECT MANAGER, PROMPT REPAIR BY THE RESPECTIVE UTILITY AND SHALL BEAR THE COST OF THE REPAIRS.

3. THE CITY OF HOBBS SHALL APPROVE MATERIAL SUBMITTALS BEFORE CONSTRUCTION

4. PRIOR TO THE SEWER LINE INSTALLATION, THE FOLLOWING CONDITIONS WILL OCCUR: A) THE SEWER LINE ROUTE WILL BE CLEARED AND GRUBBED AND THEN GRADED TO PLAN ELEVATION

5. 30 DAYS FOLLOWING INSTALLATION AN

5. 30 DAYS FOLLOWING INSTALLATION AND BACKFILL OF SEWER LINES, A DEFLECTION TEST USING A HAND PULLED MANDREL SHALL BE PERFORMED IN THE PRESENCE OF THE CITY'S INSPECTOR. ALL COSTS FOR THESE REQUIREMENTS ARE INCIDENTAL TO THE CONTRACT.

6. AIR TESTING OF SEWER LINES AND HYDROSTATIC TESTING OF FORCE MAINS SHALL BE CONDUCTED IN THE PRESENCE OF THE CITY'S INSPECTOR. ALL COSTS FOR THESE REQUIREMENTS ARE INCIDENTAL TO THE CONTRACT.

7. ALL SEWER SERVICE LINES SHALL BE INSPECTED BY TV CAMERA AND VIDEOED THEN PROVIDED TO THE CITY'S INSPECTOR FOR REVIEW BEFORE ACCEPTANCE BY THE CITY. IN THE EVENT THAT THE FIRST INSPECTION OR SUBSEQUENT INSPECTIONS AFTER THAT DO NOT PASS, THE CONTRACTOR WILL BE REQUIRED TO PERFORM ADDITIONAL INSPECTIONS OF THE SEWER SERVICE LINES USING A TV CAMERA AT THE CONTRACTOR'S EXPENSE.

8. MANHOLES SHALL MEET THE CITY OF HOBBS STANDARDS EXCEPT THAT THERE SHALL BE NO LADDER RUNGS INSTALLED.

9. THE CONTRACTOR IS RESPONSIBLE FOR TESTING OF ALL FORCE MAIN LINES, INCLUDING BUT NOT LIMITED TO HYDROSTATIC AND BACTERIA TESTING, DISINFECTING, AND FLUSHING. ALL COSTS FOR THESE REQUIREMENTS ARE INCIDENTAL TO THE CONTRACT.

10. IF BYPASS PUMPING IS REQUIRED, THEN A BYPASS PUMPING PLAN MUST BE SUBMITTED TO THE CITY'S PROJECT MANAGER, FOR ACCEPTANCE, SEVEN (7) DAYS BEFORE BYPASS PUMPING BEGINS.

11. MANHOLES SHALL BE RAISED TO SURFACE COURSE OF PAVEMENT. CIRCULAR CONCRETE COLLARS SHALL BE CONSTRUCTED TO SURFACE ELEVATION.

12. NO BRICKS SHALL BE USED TO ADJUST MANHOLES TO FINISHED GRADE.

DESIGNED:	RJF						
DRAWN:	JB						
DRAWN.	JD						
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APPROVED:		NO.	DATE	BY	REVISION		

B) THE SEWER LINE WILL BE STAKED WHEN OUTSIDE AN AREA WITH CURB AND GUTTER




CLIENT:

THE PECULIAR PEOPLE, LLC

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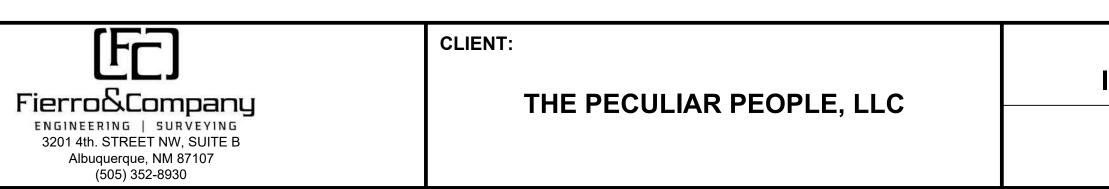
----- PROPERTY BOUNDARY -05 ____ EXISTING MINOR CONTOUR - PROPOSED MAJOR CONTOUR - PROPOSED MINOR CONTOUR EXISTING POWER POLE G -_____ EXISTING STREET LIGHT -0-PROPOSED STREET LIGHT EXISTING OVERHEAD ELECTRIC ------ OHE ------EXISTING MAIN WATERLINE — w — — w — -EXISTING SANITARY SEWER EXISTING GAS LINE _____ G _____ NEW SINGLE METER W/ SINGLE BOX NEW SANITARY SEWER LATERAL ——<u>F</u>——— NEW WATERLINE MAIN NEW SANITARY SEWER MAIN ELECTRIC LINE S EXISTING SEWER MANHOLE

LEGEND

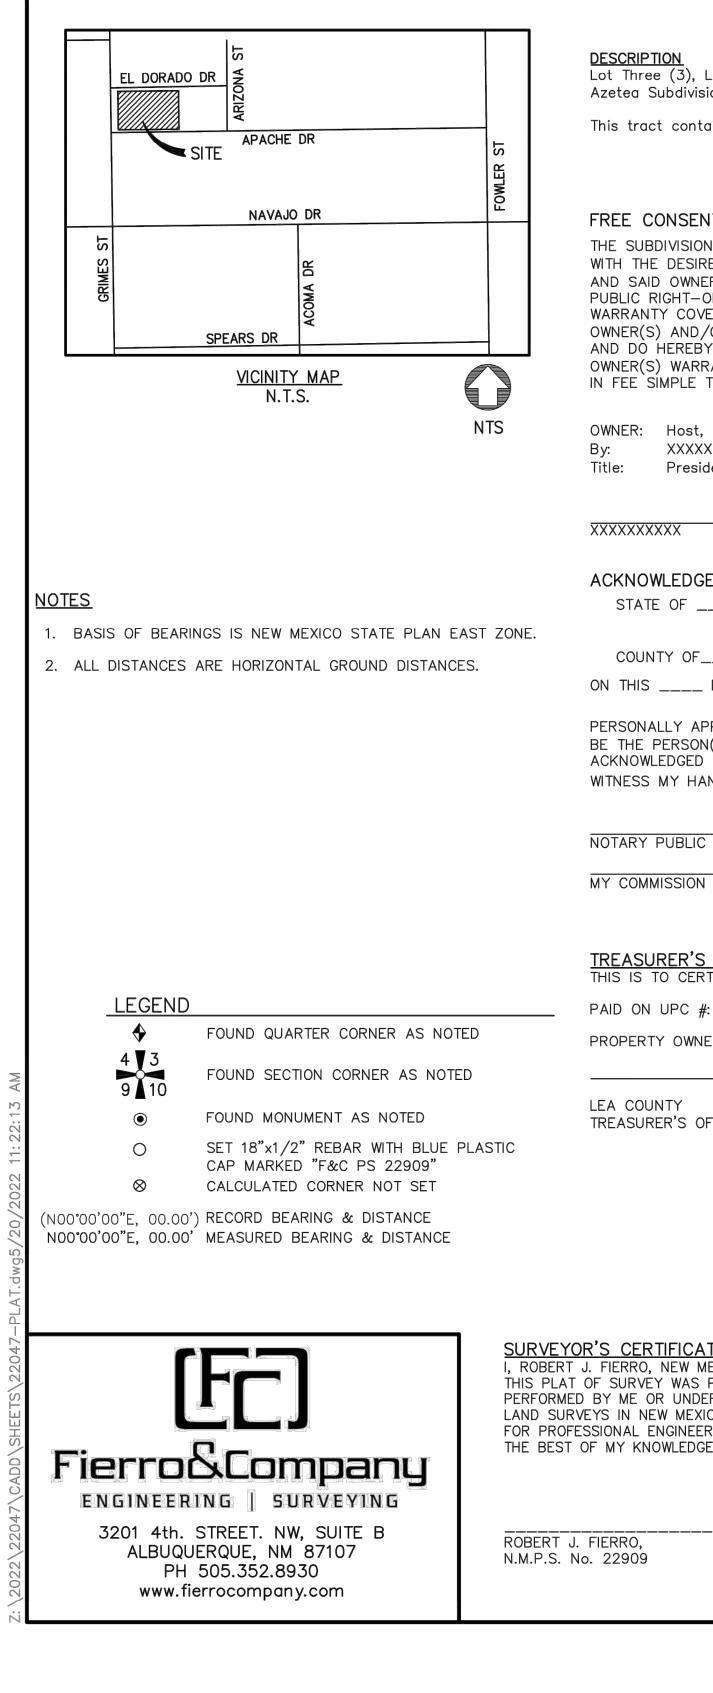

DESIGNED: RJF DRAWN: JB CHECKED: RJF APPROVED: NO. DATE BY REVISION

(FC)	CLIENT:	AZOTEA SUBDIVISION INFRASTRUCTURE IMPROVEMENTS	SHEET 4 of 13 SET 2-1
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ROBERT J. FIERRO		AT, O'CLOCKM AND RECORDED IN CABINET	
KICO AS ADOPTED BY THE NEW MEXICO STATE BOARD OF REGISTRA ERS AND PROFESSIONAL SURVEYORS; AND IS TRUE AND ACCURATE GE AND BELIEF.		,2022,	
MEXICO PROFESSIONAL SURVEYOR NO. 22909, DO HEREBY CERTIFY PREPARED FROM FIELD NOTES OF AN ACTUAL GROUND SURVEY DER MY SUPERVISION; THAT IT ACCURATELY MEETS THE STANDARDS	S FOR	COUNTY OF LEA FILED	
<u>ATION</u>		STATE OF NEW MEXICO	
	MY COMMISSION EXPIRES		
DATE	NOTARY PUBLIC		
	THIS INSTRUMENT WAS ACKNOW BY WILLIAM M. HICKS.	EDGED BEFORE ME THISDAY OF,2022,	
NER OF RECORD	COUNTY OF)		
#:	ACKNOWLEDGMENT STATE OF)	SS.	
S OFFICE CERTIFICATION RTIFY THAT THE TAXES ARE CURRENT AND	CHAIRMAN: WILLIAM M. HICKS, II		
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	BY THE CITY OF HOBBS PL		
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PPEARED KNOWN N(S) DESCRIBED IN AND WHO EXECUTED THE FOREGOING INSTRU	TO ME TO		
) _ DAY OF, 2022, BEFORE ME			
))ss.		LEDGED BEFORE ME THISDAY OF,2022 A.D,	
GEMENT:	COUNTY OF LEA	ISS.	
DATE	ACKNOWLEDGMENT STATE OF NEW MEXICO		
ident	JAN FLETCHER, CITY CLERK		
, LLC, a New Mexico corporation <xxxxxx< td=""><td></td><td></td><td></td></xxxxxx<>			
RANT THAT THEY HOLD AMONG THEM COMPLETE AND INDEFEASI TO THE LAND SUBDIVIDED.	IBLE TITLE COMMISSION OF THE CITY OF H	OBBS BY THE OF,2022 A.D.	
/OR PROPRIETOR(S) DO HEREBY CONSENT TO ALL OF THE FORE BY CERTIFY THAT THIS SUBDIVISION IS THEIR FREE ACT AND DEE	EGOING HOBBS, LEA COUNTY, NEW MEX ED. SAID PLAT OF THE MEADOWS SUBDIV	CO, DO HEREBY CERTIFY THAT THE FORGOING ISION, UNIT II, TO THE CITY OF HOBBS, WAS APPROVED BY THE	
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tains 1.326 Acres (57,780 sq.ft.), more or less.	CITY	OF HOBBS, LEA COUNTY, NEW MEXICO MAY 2022	
Lot Four (4), Lot Eleven (11), Lot Twelve (12), Block One (1), sion to the City of Hobbs, Lea County, New Mexico.	of the	SECTION 15, TOWNSHIP 18 SOUTH RANGE 38 EAST, N.M.P.M.	
		AZOTEA SUMMARY REPLAT	




PRELIMINARY PLAT


DATE Jul-2022

PROJ 22047

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PLAT OF AZOTEA SUMMARY REPLAT SECTION 15, TOWNSHIP 18 SOUTH RANGE 38 EAST, N.M.P.M. CITY OF HOBBS, LEA COUNTY, NEW MEXICO MAY 2022 W. EL DORADO DRIVE (R/W VARIES)

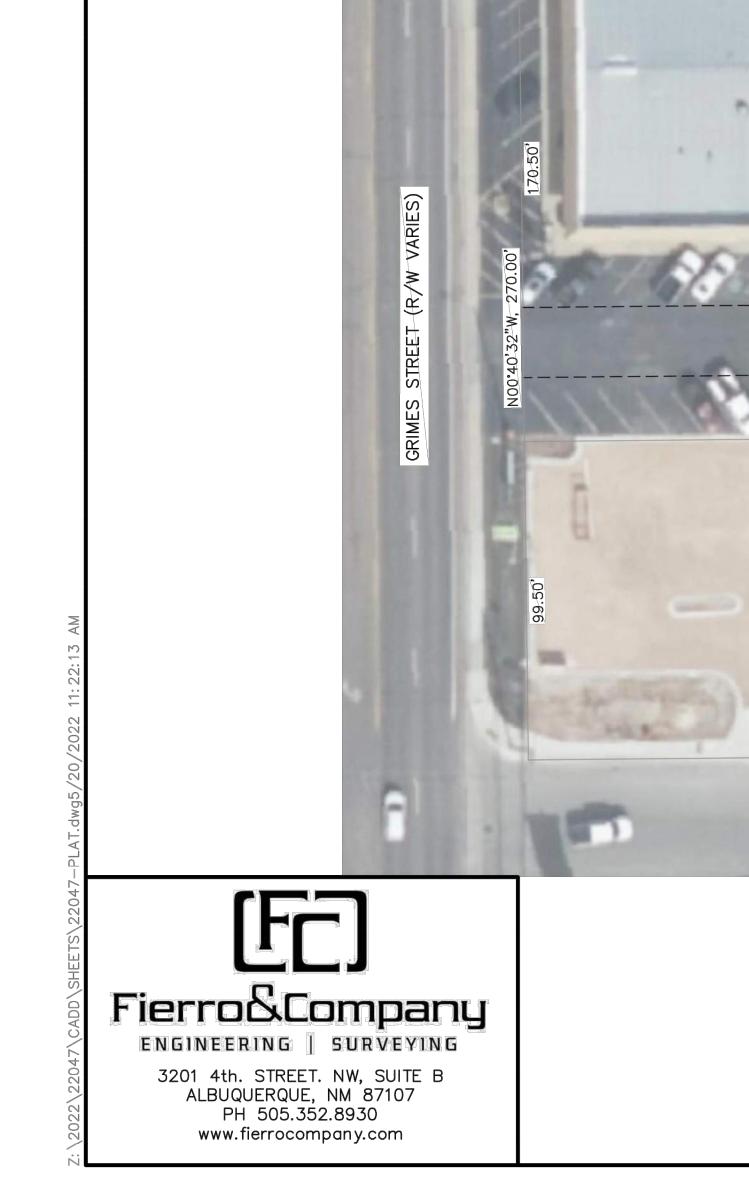


SHEET 2 OF 3

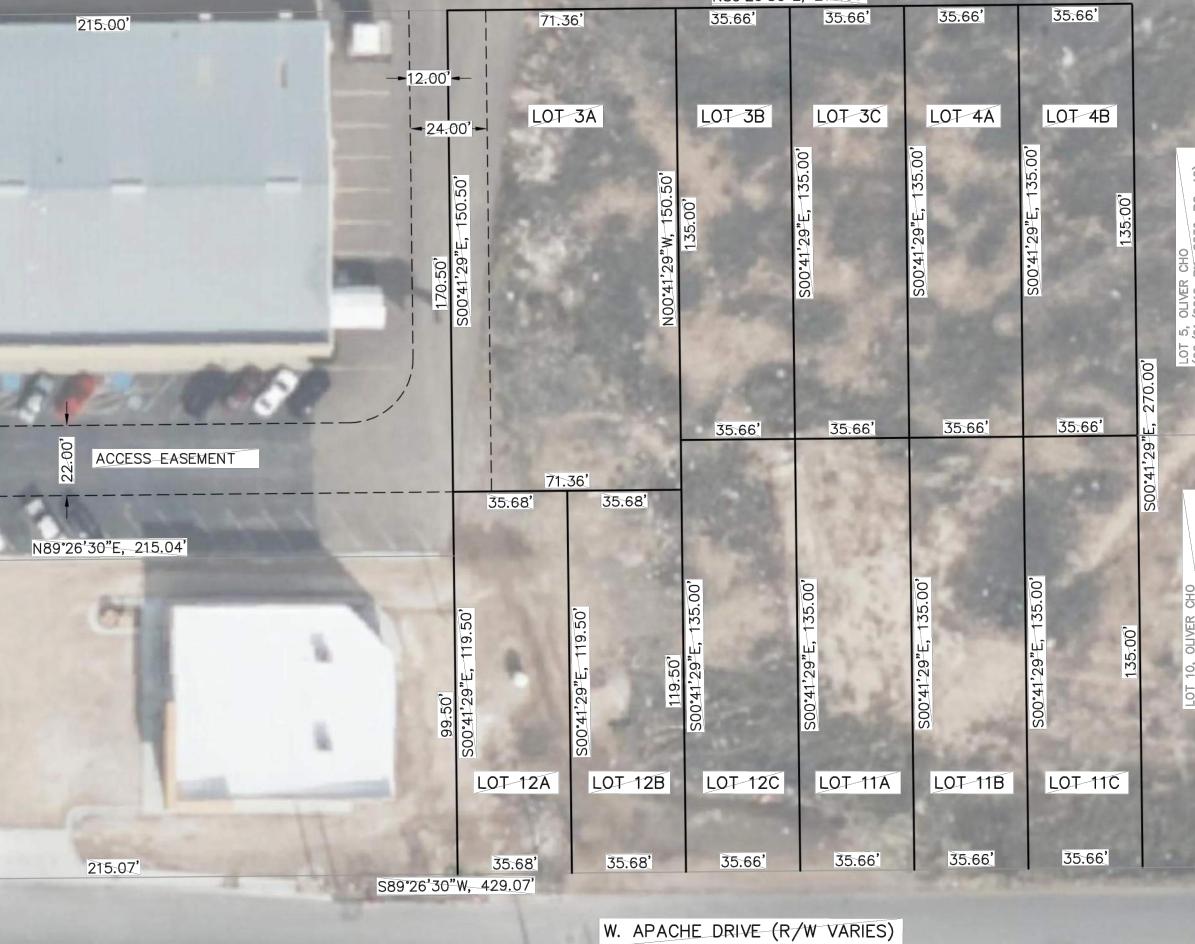 FiercoScompany
 CLIENT:

 ENGINEERING | SURVEYING
 THE PECULIAR PEOPLE, LLC

 Albuquerque, NM 87107
 (505) 352-8930

MAY 2022		
(06/01/2016; BK. 2030; Pc. 40)		
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SCALE: 1" = 30' STATE OF NEW MEXICO COUNTY OF LEA FILED ,2022, AT, O'CLOCKM AND RECORDED IN CABINET SLIDE , LEA COUNTY CLERK BYDEPUTY		
AZOTEA SUBDIVISION INFRASTRUCTURE IMPROVEMENTS PRELIMINARY PLAT	SHEET 5 of 13 SET 2-2	

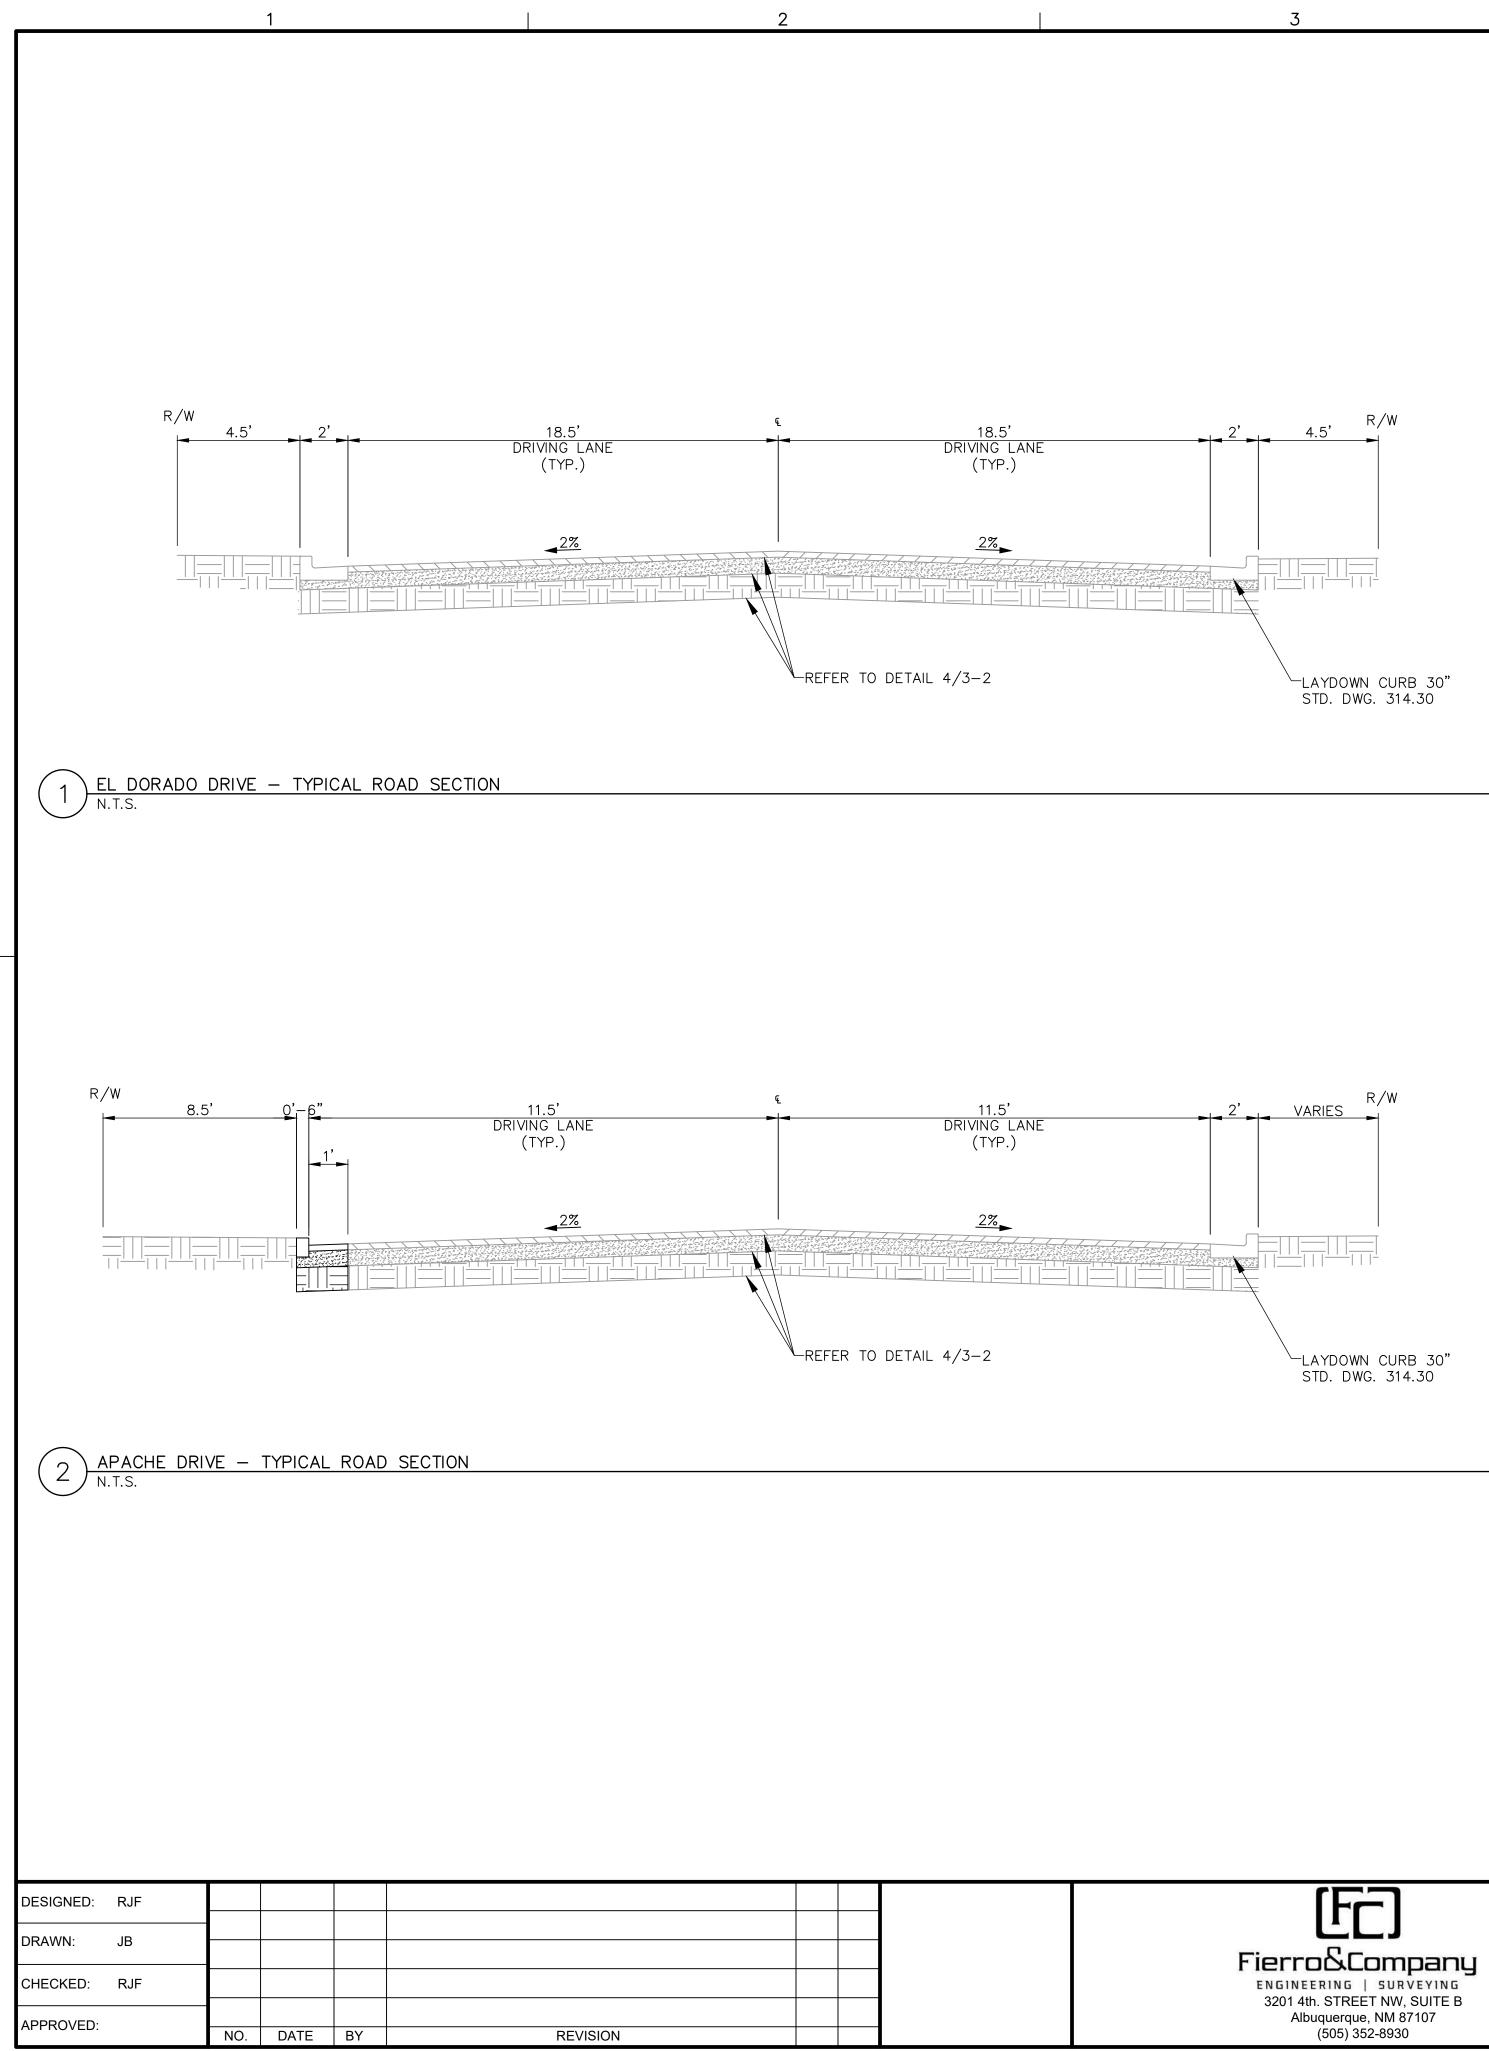

CLIENT:

THE PECULIAR PEOPLE, LLC

AZOTEA SUBDIVISION	SHEET	6 of 13
INFRASTRUCTURE IMPROVEMENTS	SET	3-1
		Jul-2022
TYPICAL ROADWAY SECTIONS	PROJ	22047

D

DESIGNED:	RJF						
DRAWN:	ID						
DRAWN: JB							
CHECKED: RJF	RJF						
APPROVED:							
AFFROVED.		NO.	DATE	BY	REVISION		

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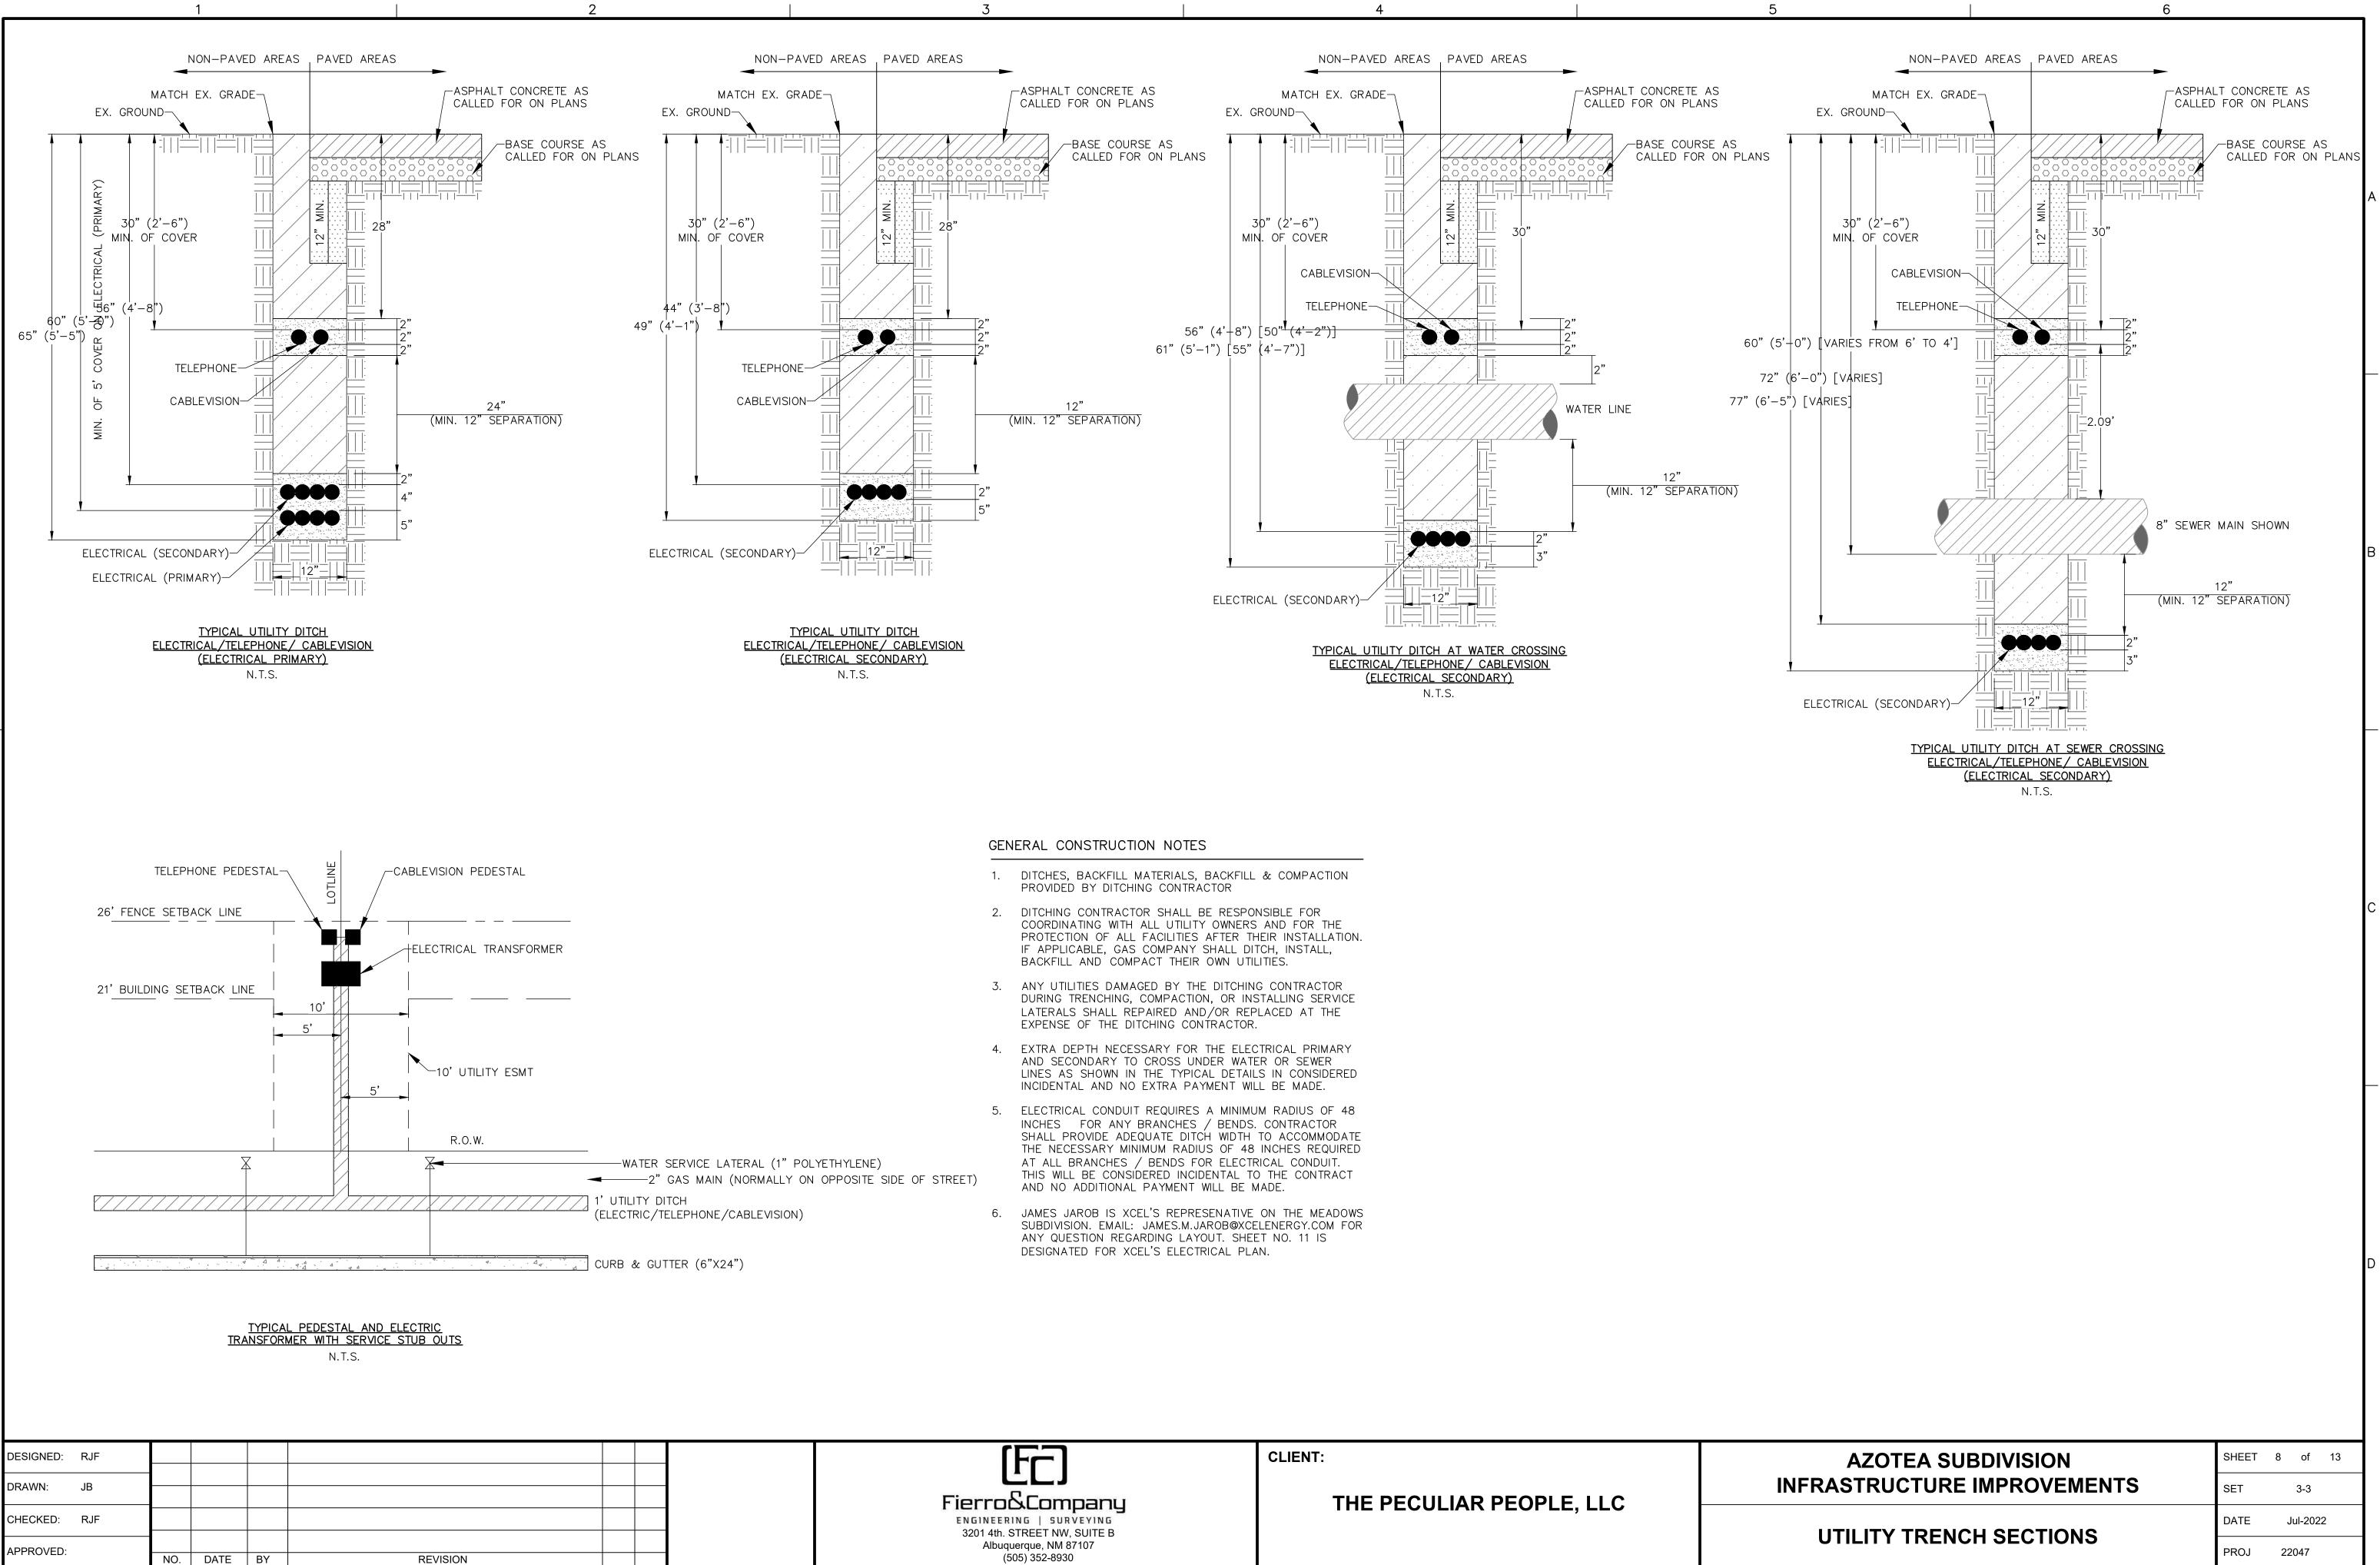


CLIENT:

THE PECULIAR PEOPLE, LLC


AZOTEA SUBDIVISION	SHEET	7 of 13
INFRASTRUCTURE IMPROVEMENTS	SET	3-2
	DATE	Jul-2022
EXCEL ELECTRICAL LAYOUT	PROJ	22047


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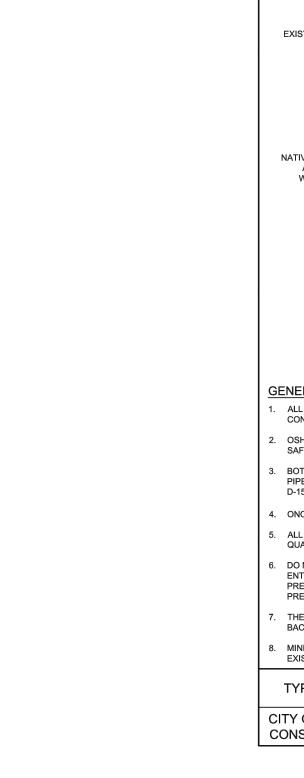


AZOTEA SUBDIVISION	SHEET	8 of 13
INFRASTRUCTURE IMPROVEMENTS	SET	3-3
	DATE	Jul-2022
UTILITY TRENCH SECTIONS	PROJ	22047

DESIGNED:	RJF						
DRAWN:	ID						
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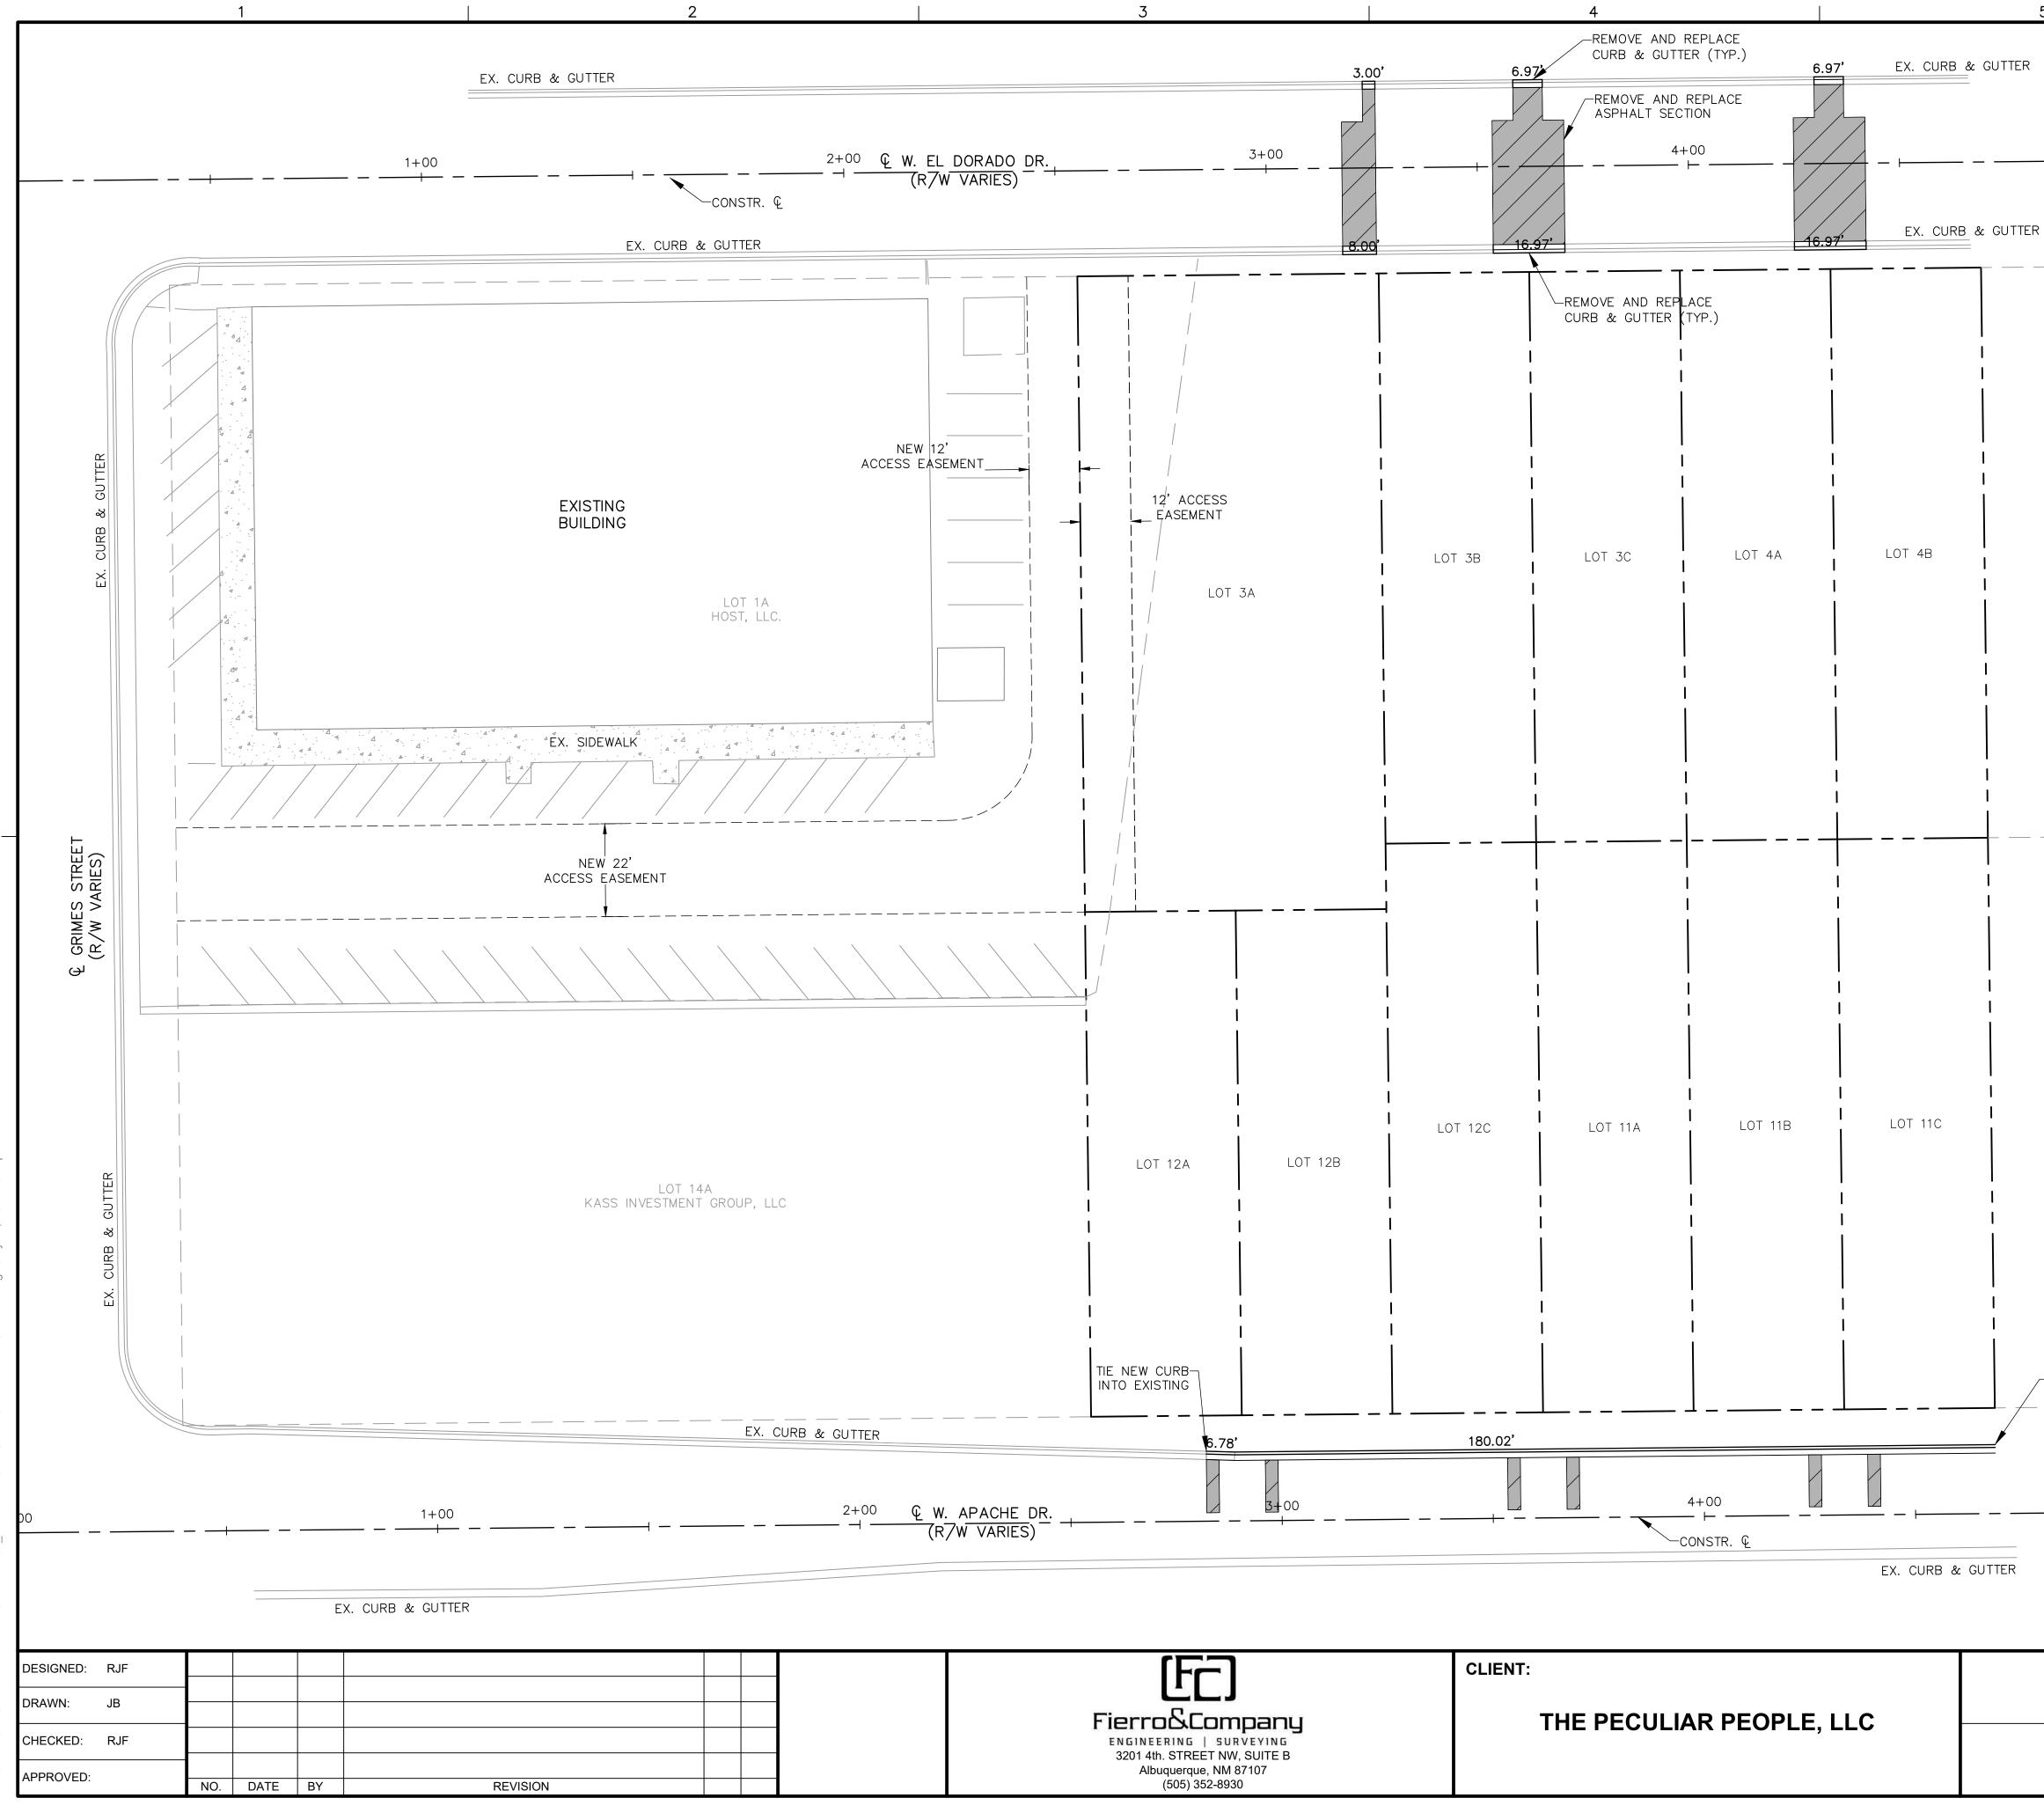


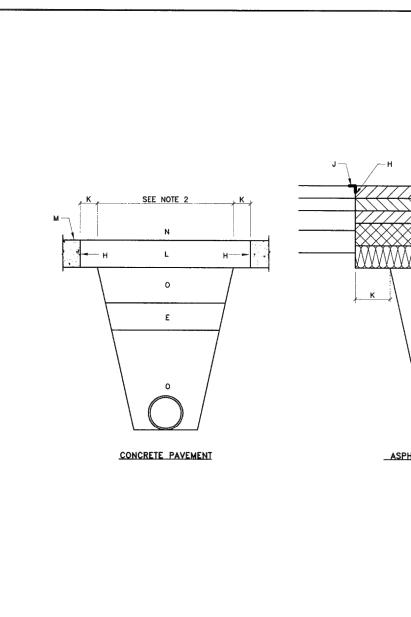


CLIENT:

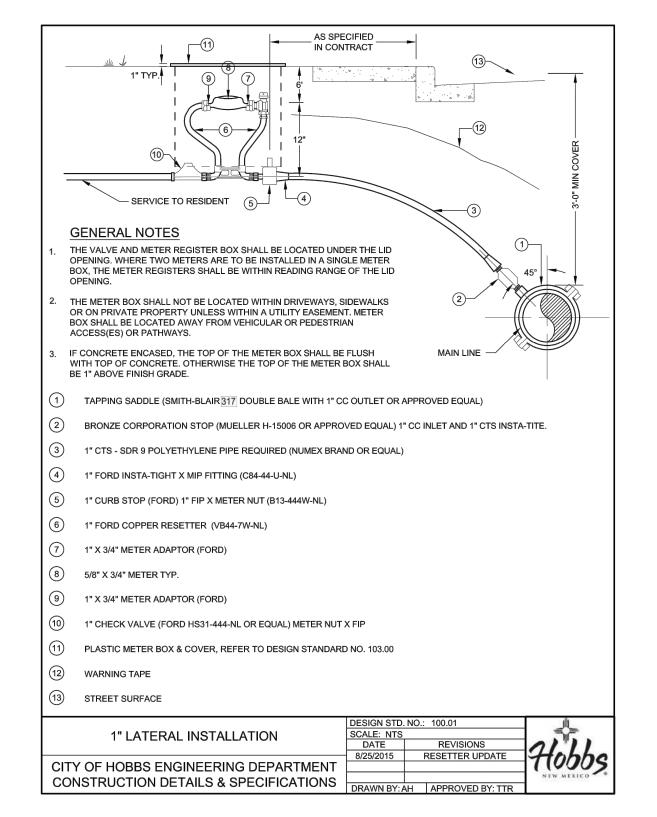THE PECULIAR PEOPLE, LLC

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8. MINIMUM PAVEMENT AND BASE COURSE THICKNESS ARE SHOWN ON THIS DETAIL. THE CONTRACTOR SHALL MATCH THE EXISTING PAVEMENT SECTION IF IT IS GREATER THAN SHOWN ON THIS DETAIL. TYPICAL TRENCH AND BACKFILL DETAIL DESIGN STD. NO.: 501.00 SCALE: NTS DATE TREVISIONS CITY OF HOBBS ENGINEERING DEPARTMENT CONSTRUCTION DETAILS & SPECIFICATIONS DATE TREVISIONS DATE REVISIONS 3/22/12 DATE DATE NO.: 501.00 DATE DATE CITY OF HOBBS ENGINEERING DEPARTMENT CONSTRUCTION DETAILS & SPECIFICATIONS DRAWN BY: ZS APPROVED BY: TTR	SHEET	9	of	13	
INFRASTRUCTURE IMPROVEMENTS UTILITY DETAILS	SET DATE PROJ		3-4 ul-202 !047	2	




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OVERALL UTILITY PLAN	PROJ 22047	
AZOTEA SUBDIVISION INFRASTRUCTURE IMPROVEMENTS	SHEET 11 of 13 SET 5-0 DATE Jul-2022	
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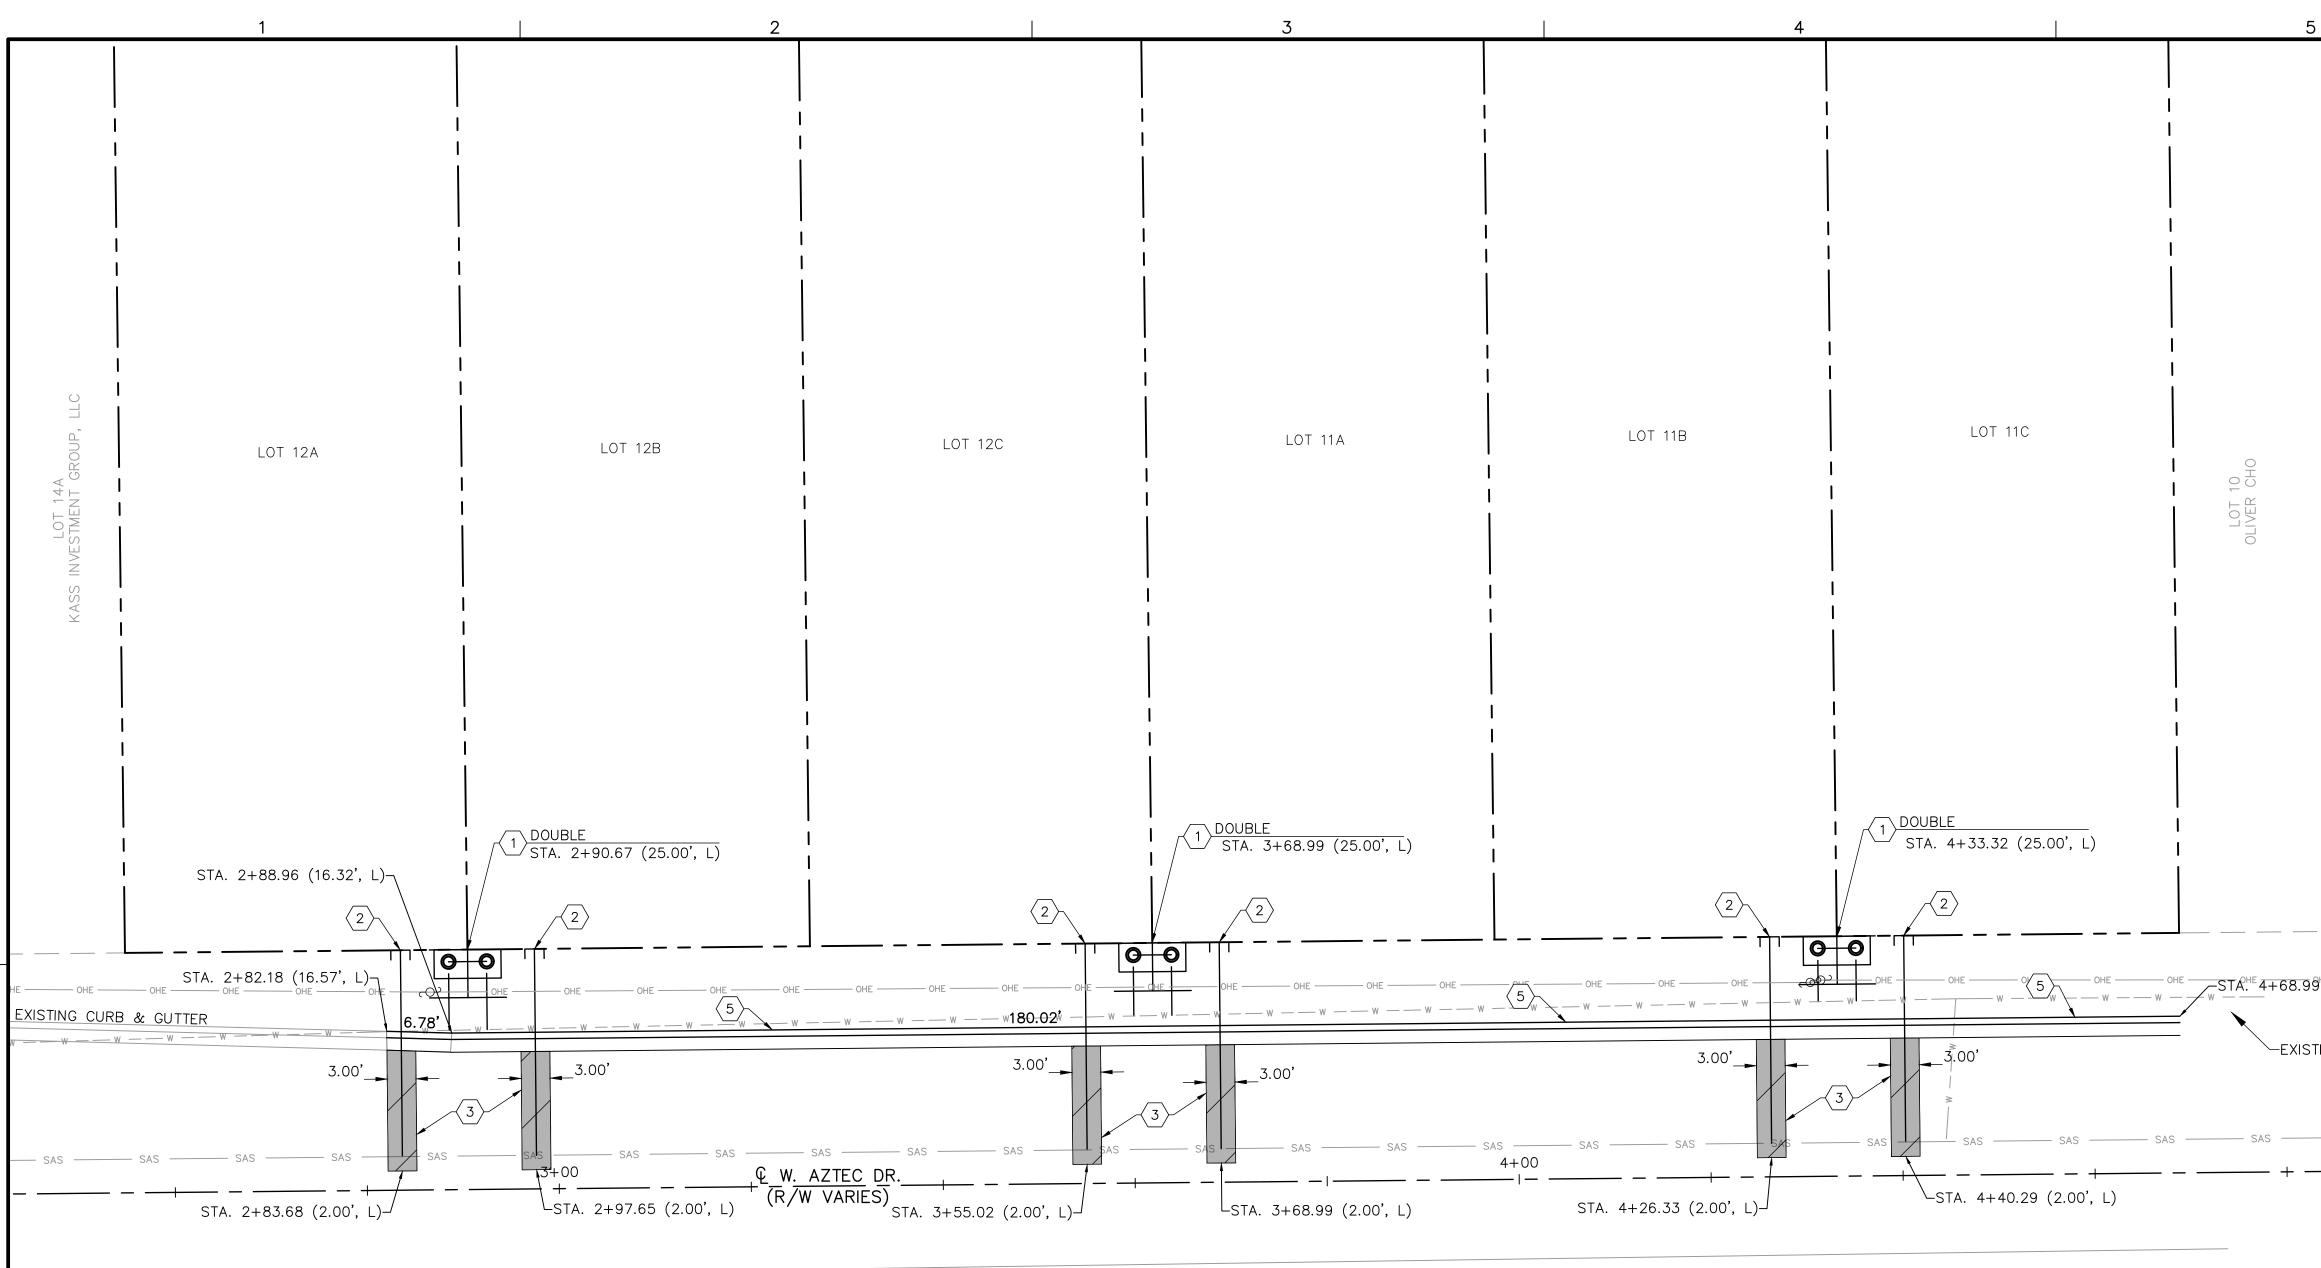

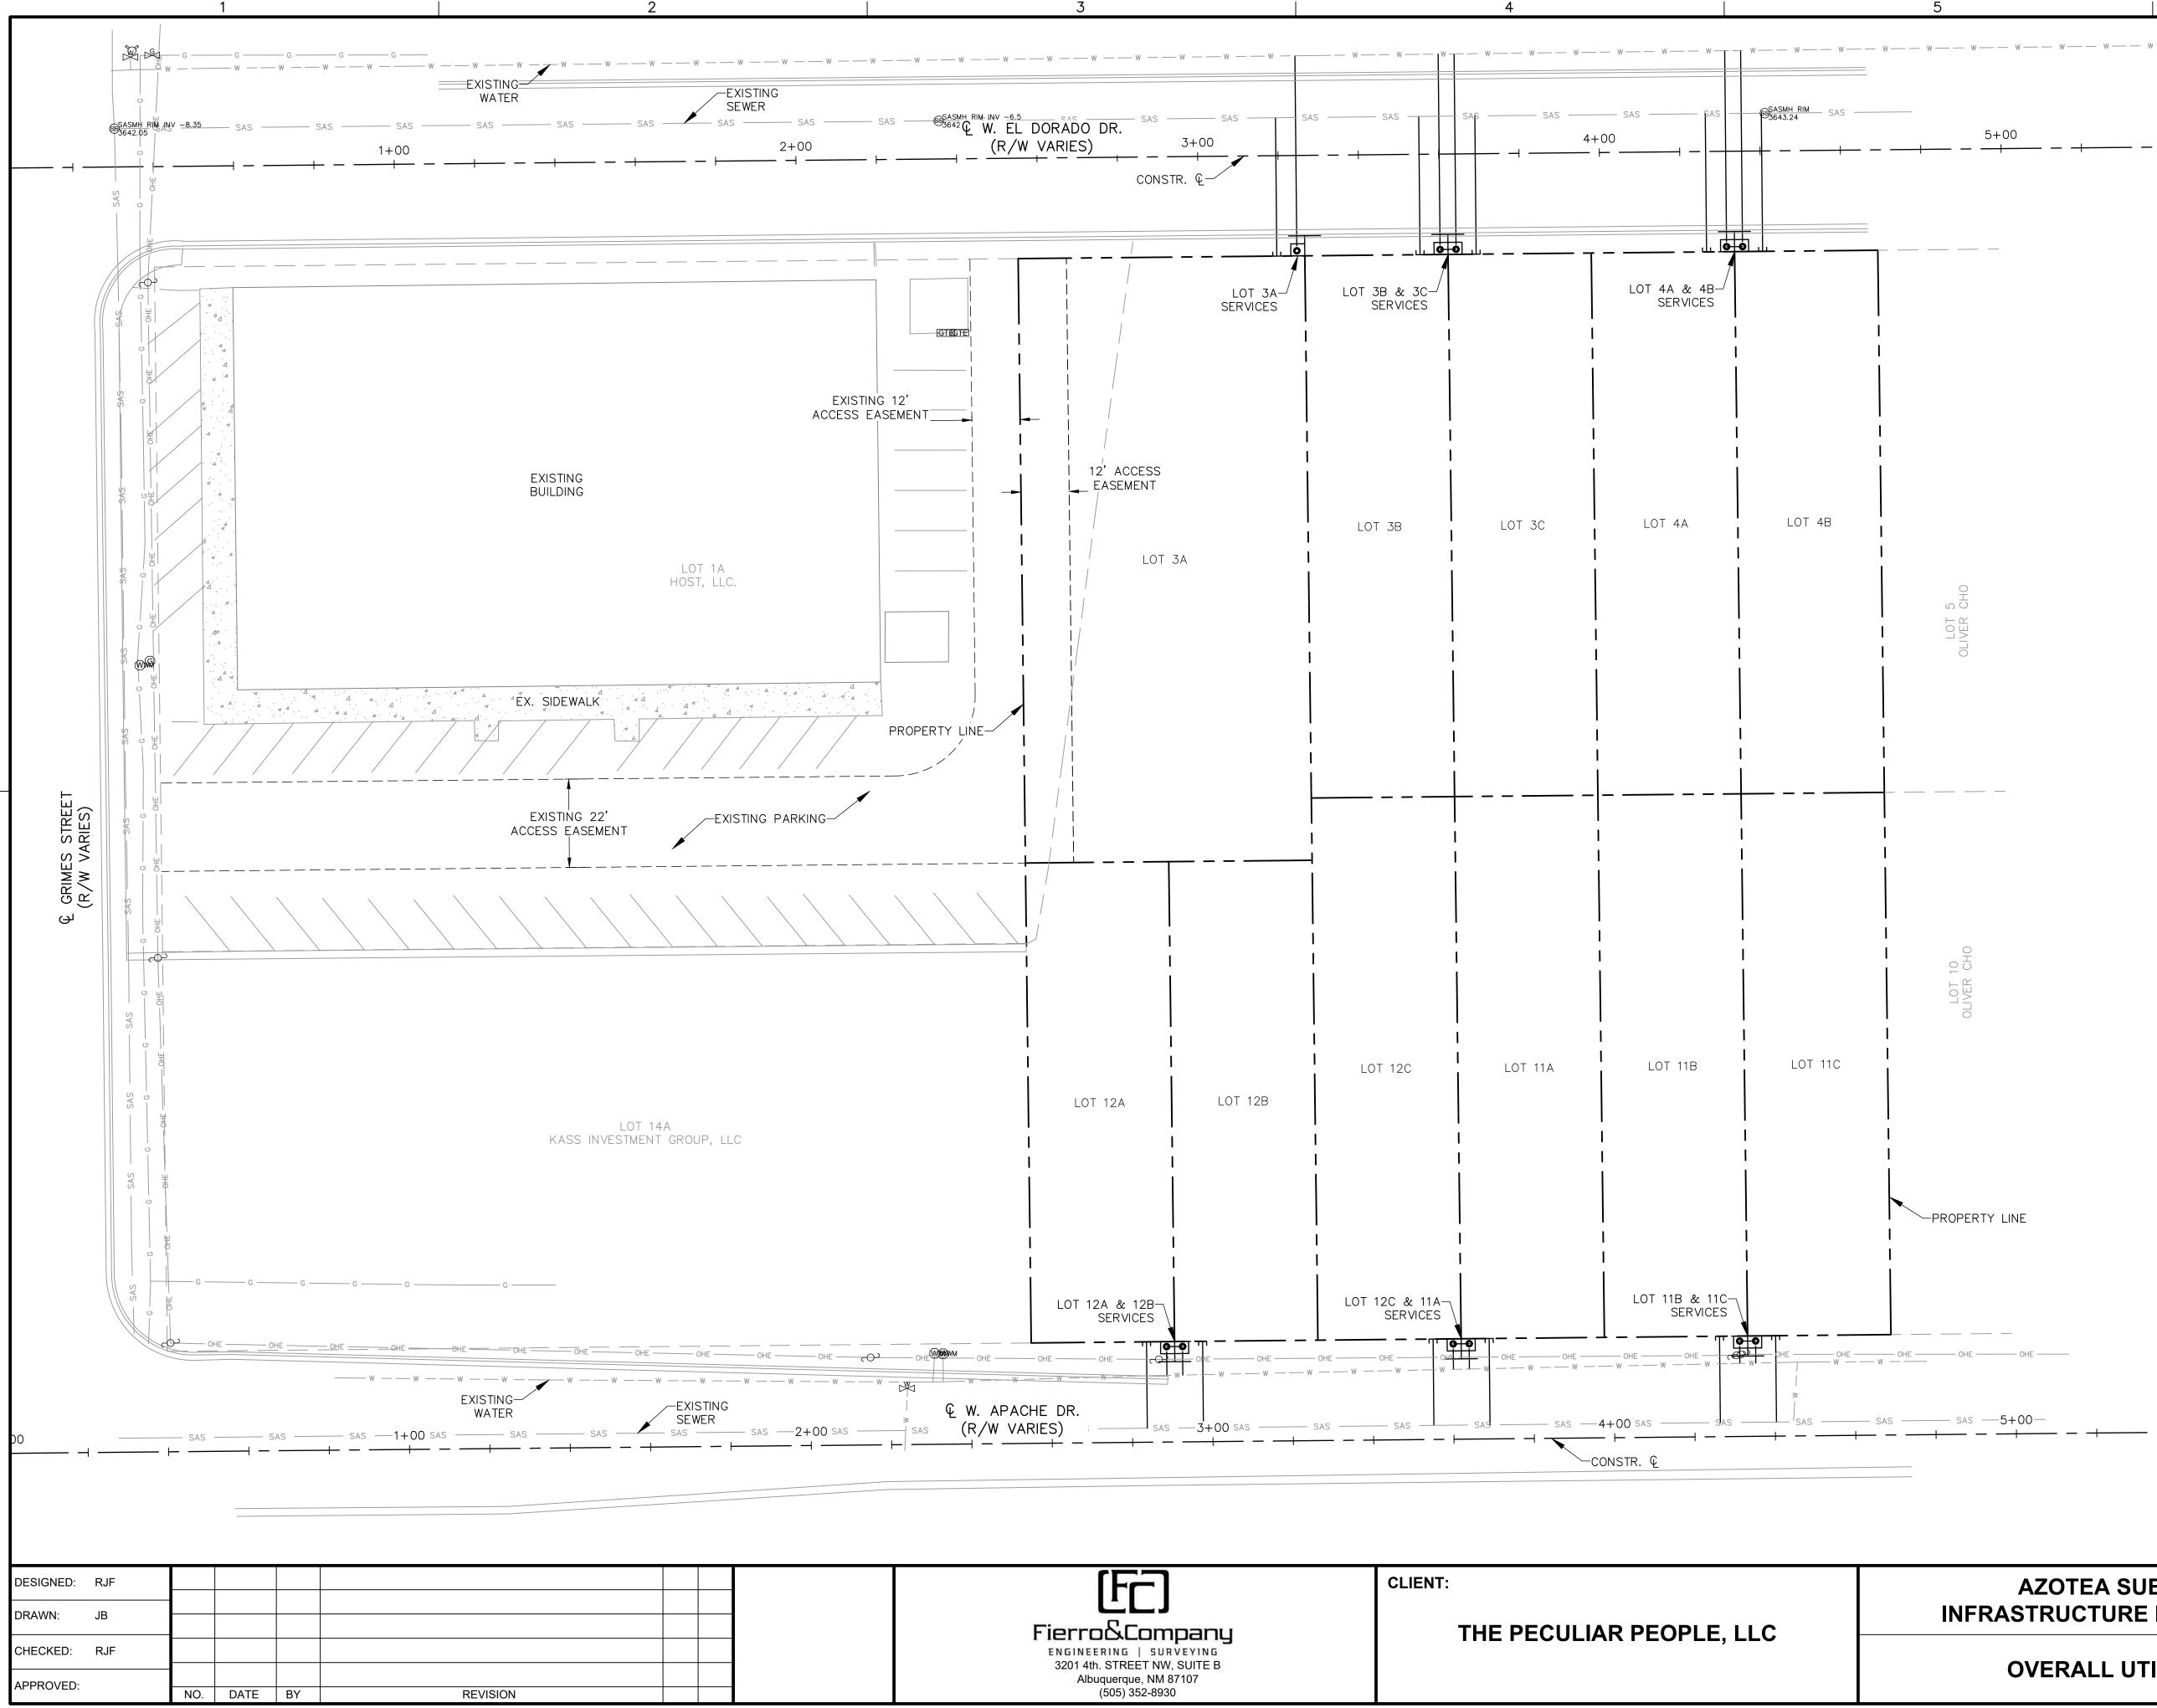
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	6	
	1 INSTALL 1" WATER LATERAL SERVI PER C.O.H. DESIGN STD. NO. 100.(
	2 INSTALL 4" SEWER SERVICE LINE.	
	3 REMOVE AND REPLACE ASPHALT S PER APWA STD. DWG. 2465.	
	4 REMOVE AND DISPOSE CURB AND PER DETAIL 3/3-1.	GUTTER
	5 CONSTRUCT 6"X24" (STANDARD) (PER C.O.H. DESIGN STD. NO. 310.(CURB & GUTTER 01.
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AZOTEA SU	BDIVISION	SHEET 12 of 13
	IMPROVEMENTS	SET 5-1
W. EL DOF	RADO DR.	DATE Jul-2022
UTILITY		PROJ 22047
		<u> </u>



EXISTING CURB & GUTTER

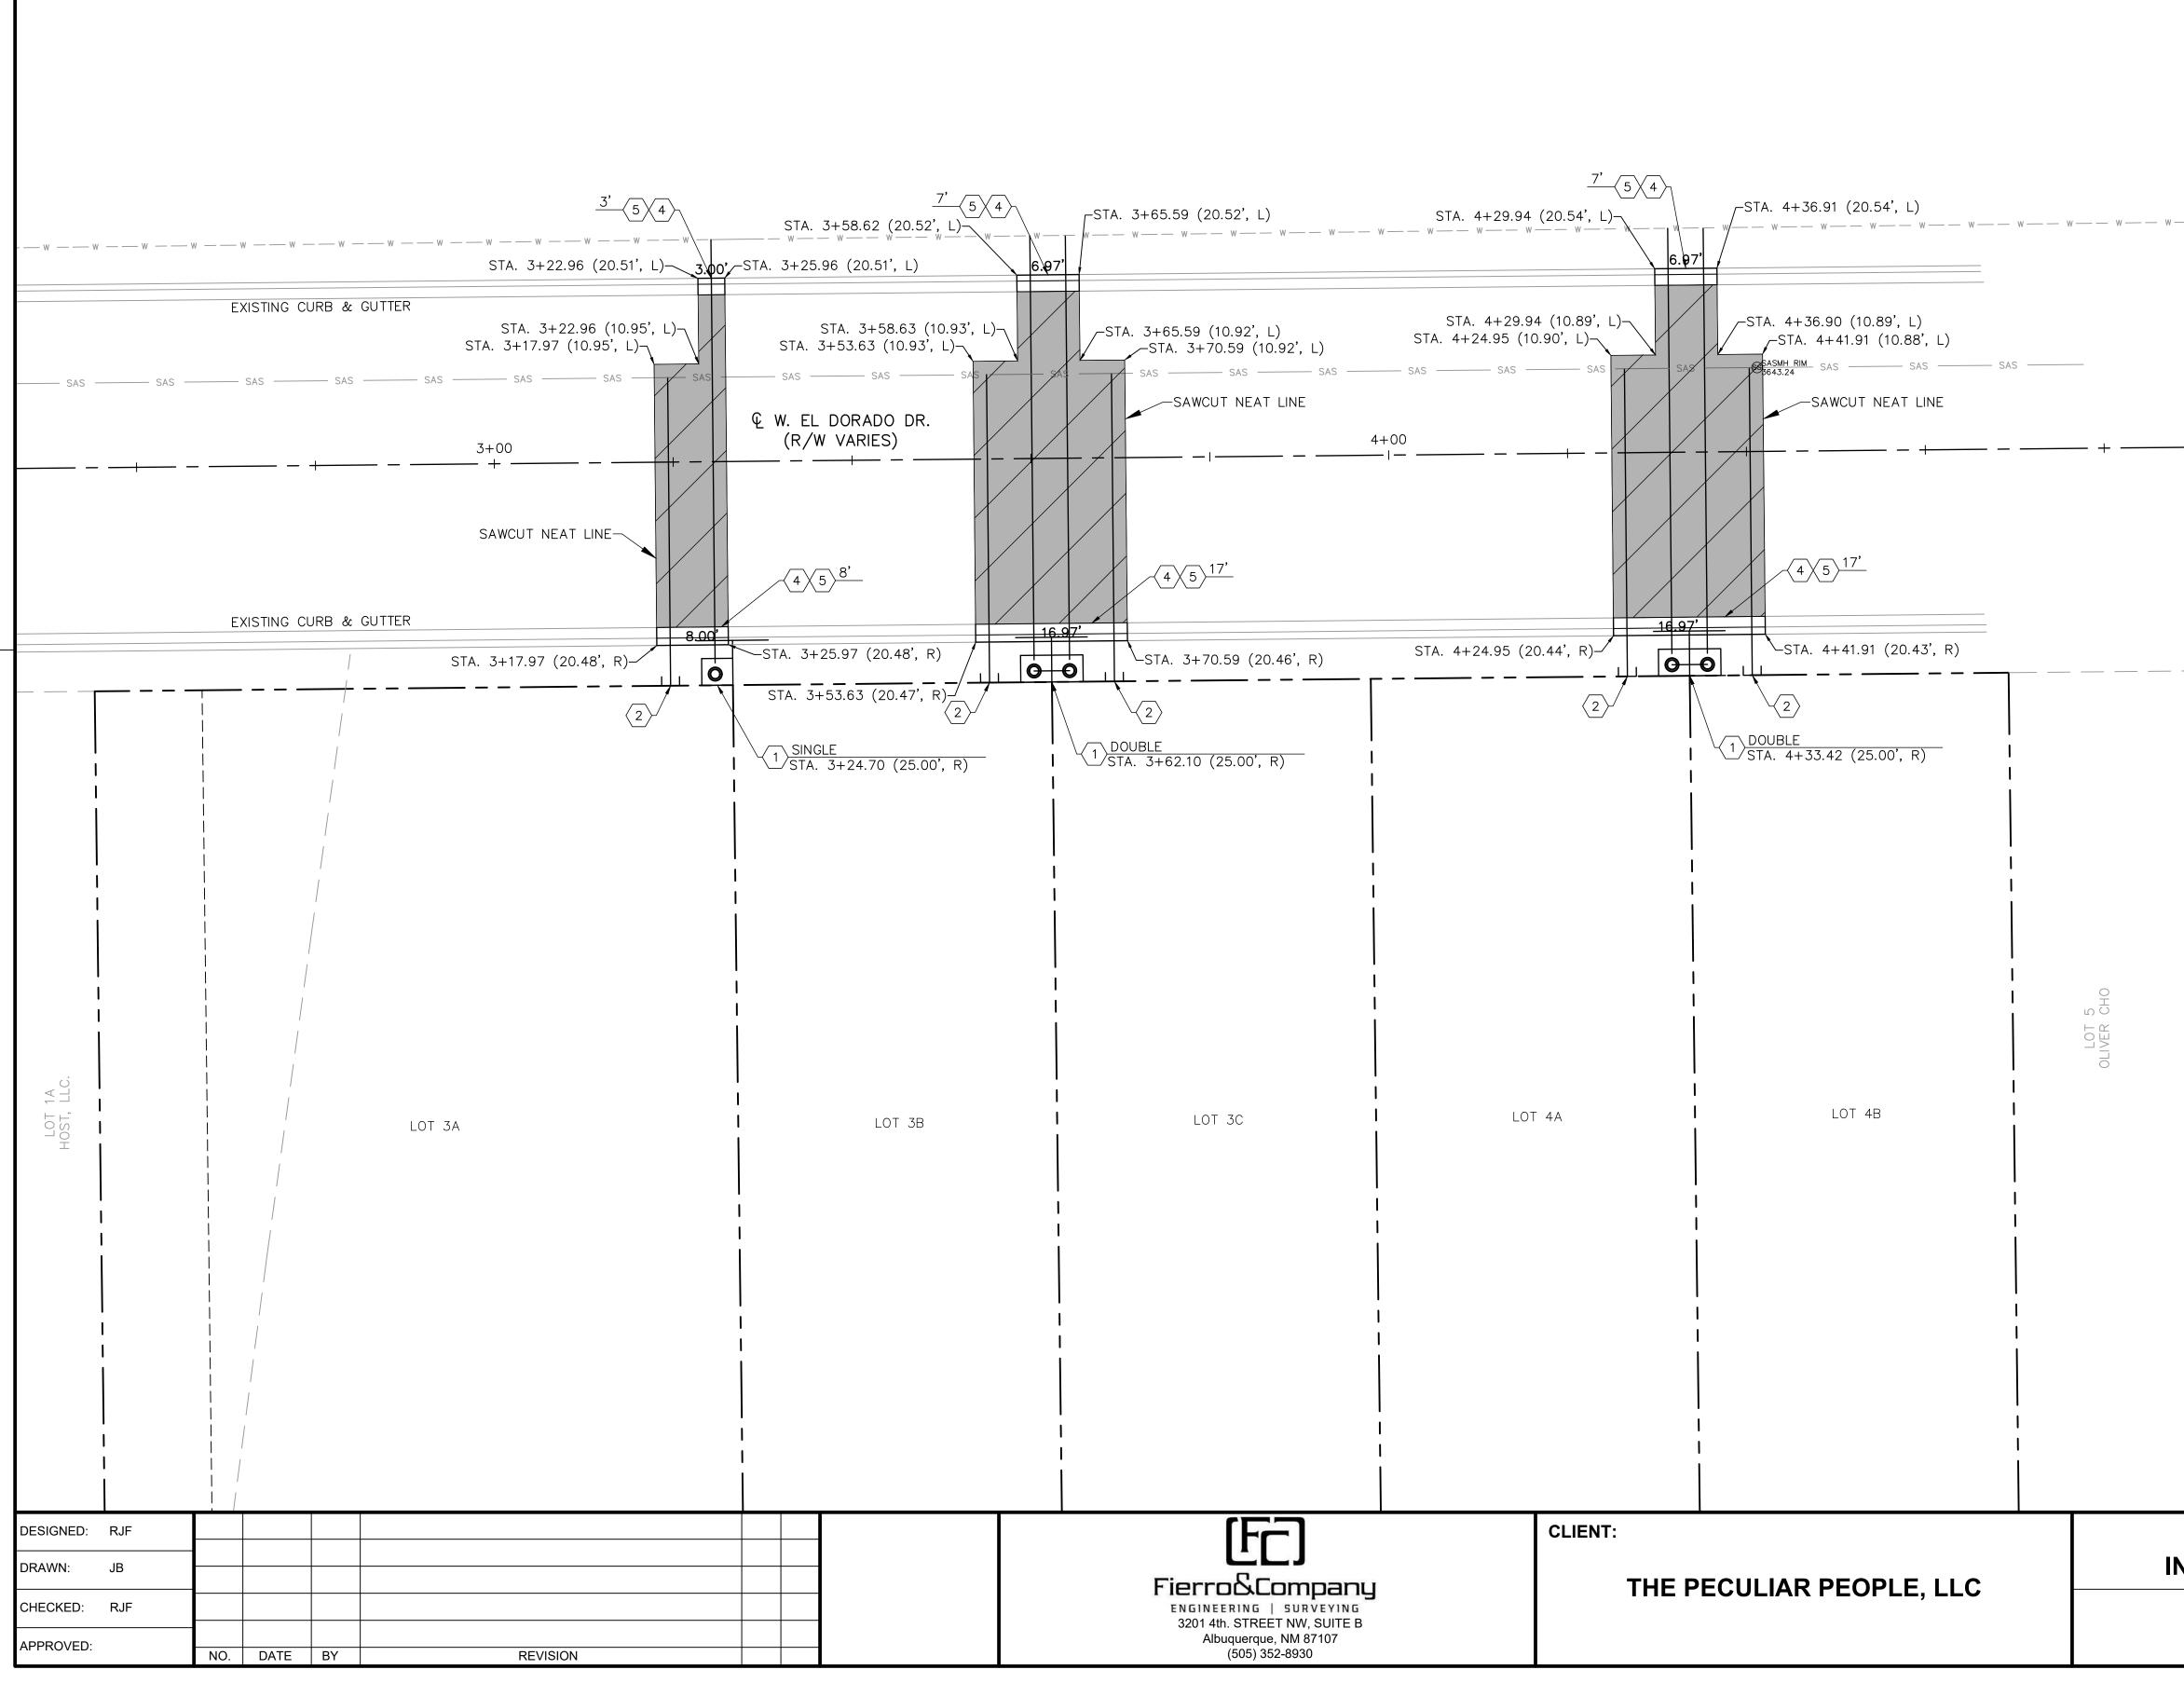DESIGNED:	RJF						
DRAWN:	JB						
DRAWN.	JD						
CHECKED:	RJF						
APPROVED:							
AFFROVED.		NO.	DATE	BY	REVISION		


EXISTING CURB & GUTTER



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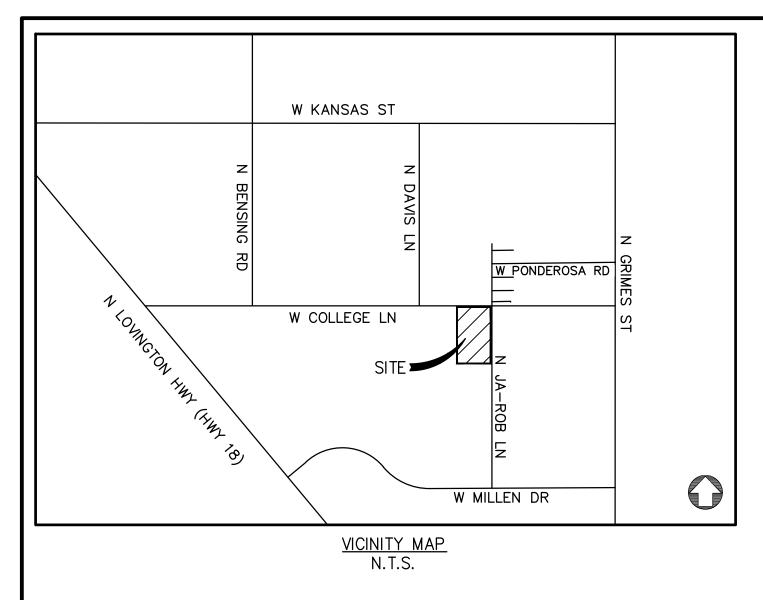
THE PECULIAR PEOPLE, LLC

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	\bigcirc CONSTRUCTION NOTES	7
	 INSTALL 1" WATER LATERAL SERVICE WITH METER BOX PER C.O.H. DESIGN STD. NO. 100.01. 	
	2 INSTALL 4" SEWER SERVICE LINE.	
	3 REMOVE AND REPLACE ASPHALT SECTION. PER APWA STD. DWG. 2465.	
	4 REMOVE AND DISPOSE CURB AND GUTTER PER DETAIL 3/3–1.	
	5 CONSTRUCT 6"X24" (STANDARD) CURB & GUTTER PER C.O.H. DESIGN STD. NO. 310.01.	A
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AZOTEA SUBDIVISION INFRASTRUCTURE IMPROVEMENTS	SHEET SET	13 of 13 5-2
W. APACHE DR.	DATE	Jul-2022
UTILITY PLAN	PROJ	22047

6) Review and Consider NDEY Subdivision, Unit 1 Final Plat Approval, as presented by property owner Maria Ndey.

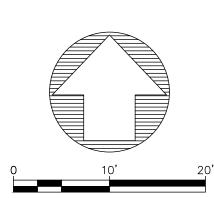

DESCRIPTION

TRACT FIVE (5) OF THE LYNCH SUBDIVISION TO LEA COU ON THAT CERTAIN PLAT FILED JANUARY 23, 2015, IN BO RECORDS, LEA COUNTY, NEW MEXICO

FREE CONSENT AND DEDICATION


THE SUBDIVISION HEREON DESCRIBED IS WITH THE FREE THE DESIRES OF THE UNDERSIGNED OWNER(S) AND/OR OWNER(S) AND/OR PROPRIETOR(S) DO HEREBY DEDICATE RIGHT-OF-WAYS SHOWN HEREON TO THE CITY OF HOBE COVENANTS.

SAID OWNER(S) AND/OR PROPRIETOR(S) DO HEREBY GR SAID OWNER(S) AND/OR PROPRIETOR(S) DO HEREBY CO DO HEREBY CERTIFY THAT THIS SUBDIVISION IS THEIR FI SAID OWNER(S) AND/OR PROPRIETOR(S) WARRANT THAT AND INDEFEASIBLE TITLE IN FEE SIMPLE TO THE LAND S

OWNER: MARIA NDEY

MARIA NDEY

ACKNOWLEDGEMENT:

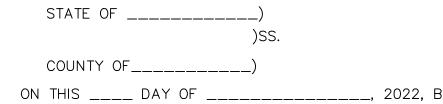

PERSONALLY APPEARED ______ THE PERSON(S) DESCRIBED IN AND WHO EXECUTED THE ACKNOWLEDGED THAT THEY EXECUTED THE SAME AS TH WITNESS MY HAND AND OFFICIAL SEAL THE DAY AND YE

NOTARY PUBLIC

MY COMMISSION EXPIRES

SURVEYOR'S CERTIFICATION I, ROBERT J. FIERRO, NEW MEXICO PROFESSIONAL SURVEYO THIS PLAT OF SURVEY WAS PREPARED FROM FIELD NOTES PERFORMED BY ME OR UNDER MY SUPERVISION; THAT IT A LAND SURVEYS IN NEW MEXICO AS ADOPTED BY THE NEW FOR PROFESSIONAL ENGINEERS AND PROFESSIONAL SURVEY THE BEST OF MY KNOWLEDGE AND BELIEF.



<u>NOTES</u>

LEGEND

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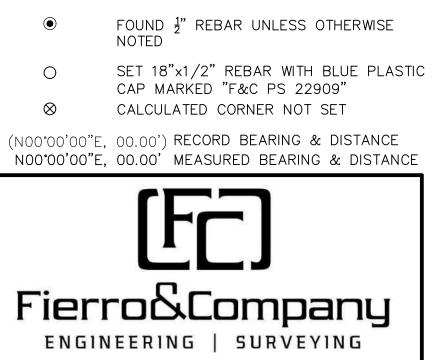
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1. BASIS OF BEARINGS IS NEW MEXICO STATE PLANE EAST ZONE.

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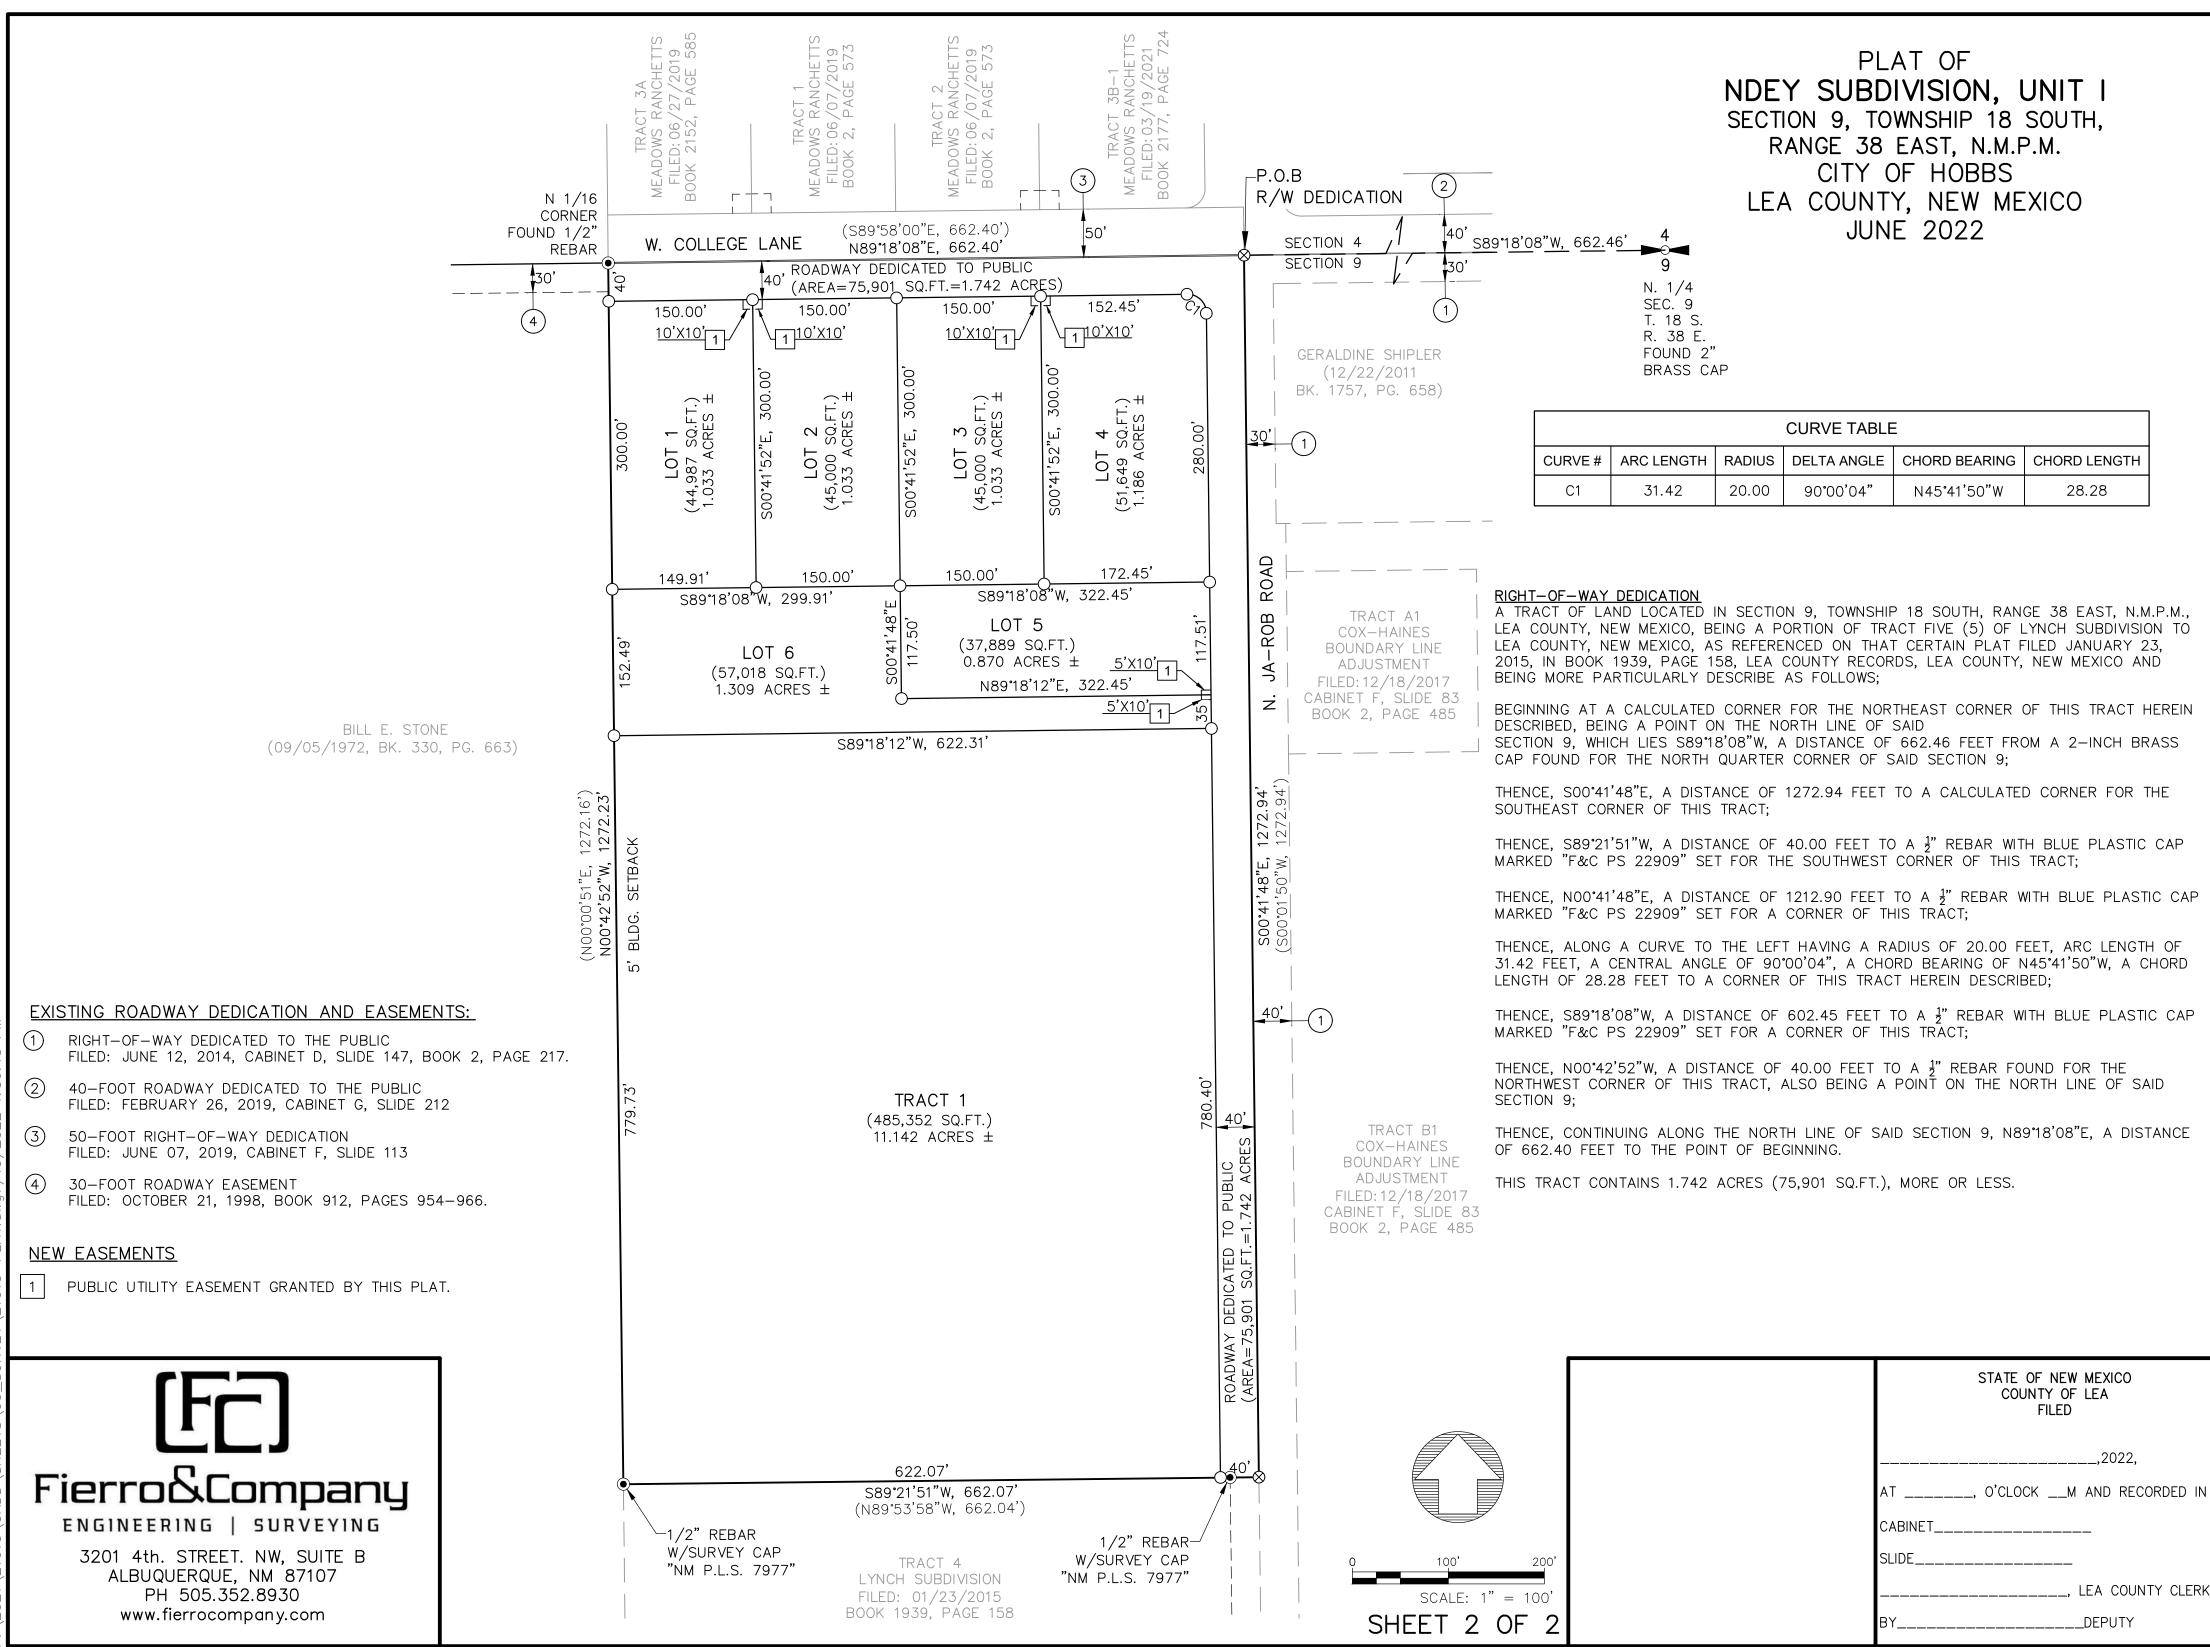
FOUND SECTION CORNER AS NOTED

2. ALL DISTANCES ARE HORIZONTAL GROUND DISTANCES.




3201 4th. STREET. NW, SUITE B ALBUQUERQUE, NM 87107 PH 505.352.8930 www.fierrocompany.com

	SECTIO RAN	PLAT OF SUBDIVISION, UNIT I N 9, TOWNSHIP 18 SOUTH, NGE 38 EAST, N.M.P.M. CITY OF HOBBS COUNTY, NEW MEXICO JUNE 2022
	CERTIFICATE OF MUNICIPAL APPRON I, JAN FLETCHER, THE DULY APPOINTED A HOBBS, LEA COUNTY, NEW MEXICO, DO HE PLAT OF THE MEADOWS SUBDIVISION, UNIT THE COMMISSION OF THE CITY OF HOBBS RESOLUTION No ON THE OF	ND ACTING CITY CLERK OF THE CITY OF EREBY CERTIFY THAT THE FORGOING T III, TO THE CITY OF HOBBS, WAS APPROVED BY BY
OUNTY, NEW MEXICO, AS REFERENCED BOOK 1939, PAGE 158, LEA COUNTY	JAN FLETCHER, CITY CLERK	_
CONSENT AND IN ACCORDANCE WITH PROPRIETOR(S) THEREOF AND SAID E ALL STREET AND PUBLIC BS IN FEE SIMPLE WITH WARRANTY	THIS INSTRUMENT WAS ACKNOWLEDGED BE	FORE ME THISDAY OF,2022 A.D,
ANT ALL EASEMENTS SHOWN HEREON. INSENT TO ALL OF THE FOREGOING AND REE ACT AND DEED. I THEY HOLD AMONG THEM COMPLETE SUBDIVIDED.	NOTARY PUBLIC MY COMMISSION EXPIRES	
DATE	CERTIFICATE OF APPROVAL BY THE CITY OF HOBBS PLANNING THE PLAT, RESTRICTIONS AND DEDICATION OF,2022 A.D. BY THE CITY	
FOREGOING INSTRUMENT AND	CHAIRMAN: WILLIAM M. HICKS, III ACKNOWLEDGMENT STATE OF STATE OF)SS. COUNTY OF)THIS INSTRUMENT WAS ACKNOWLEDGED BE BY WILIAM M. HICKS.	_ Fore me thisday of,2022,
	NOTARY PUBLIC MY COMMISSION EXPIRES	_
OR NO. 22909, DO HEREBY CERTIFY THAT OF AN ACTUAL GROUND SURVEY ACCURATELY MEETS THE STANDARDS FOR MEXICO STATE BOARD OF REGISTRATION YORS; AND IS TRUE AND ACCURATE TO		STATE OF NEW MEXICO COUNTY OF LEA FILED , 2022, AT, O'CLOCKM AND RECORDED IN CABINET SLIDE
SHEET 1 (DF 2	, LEA COUNTY CLERK




7) Review and Consider Final Plat Approval Westminster Hollow, Third Village, as presented by property owner, Del Norte Heights, Inc..

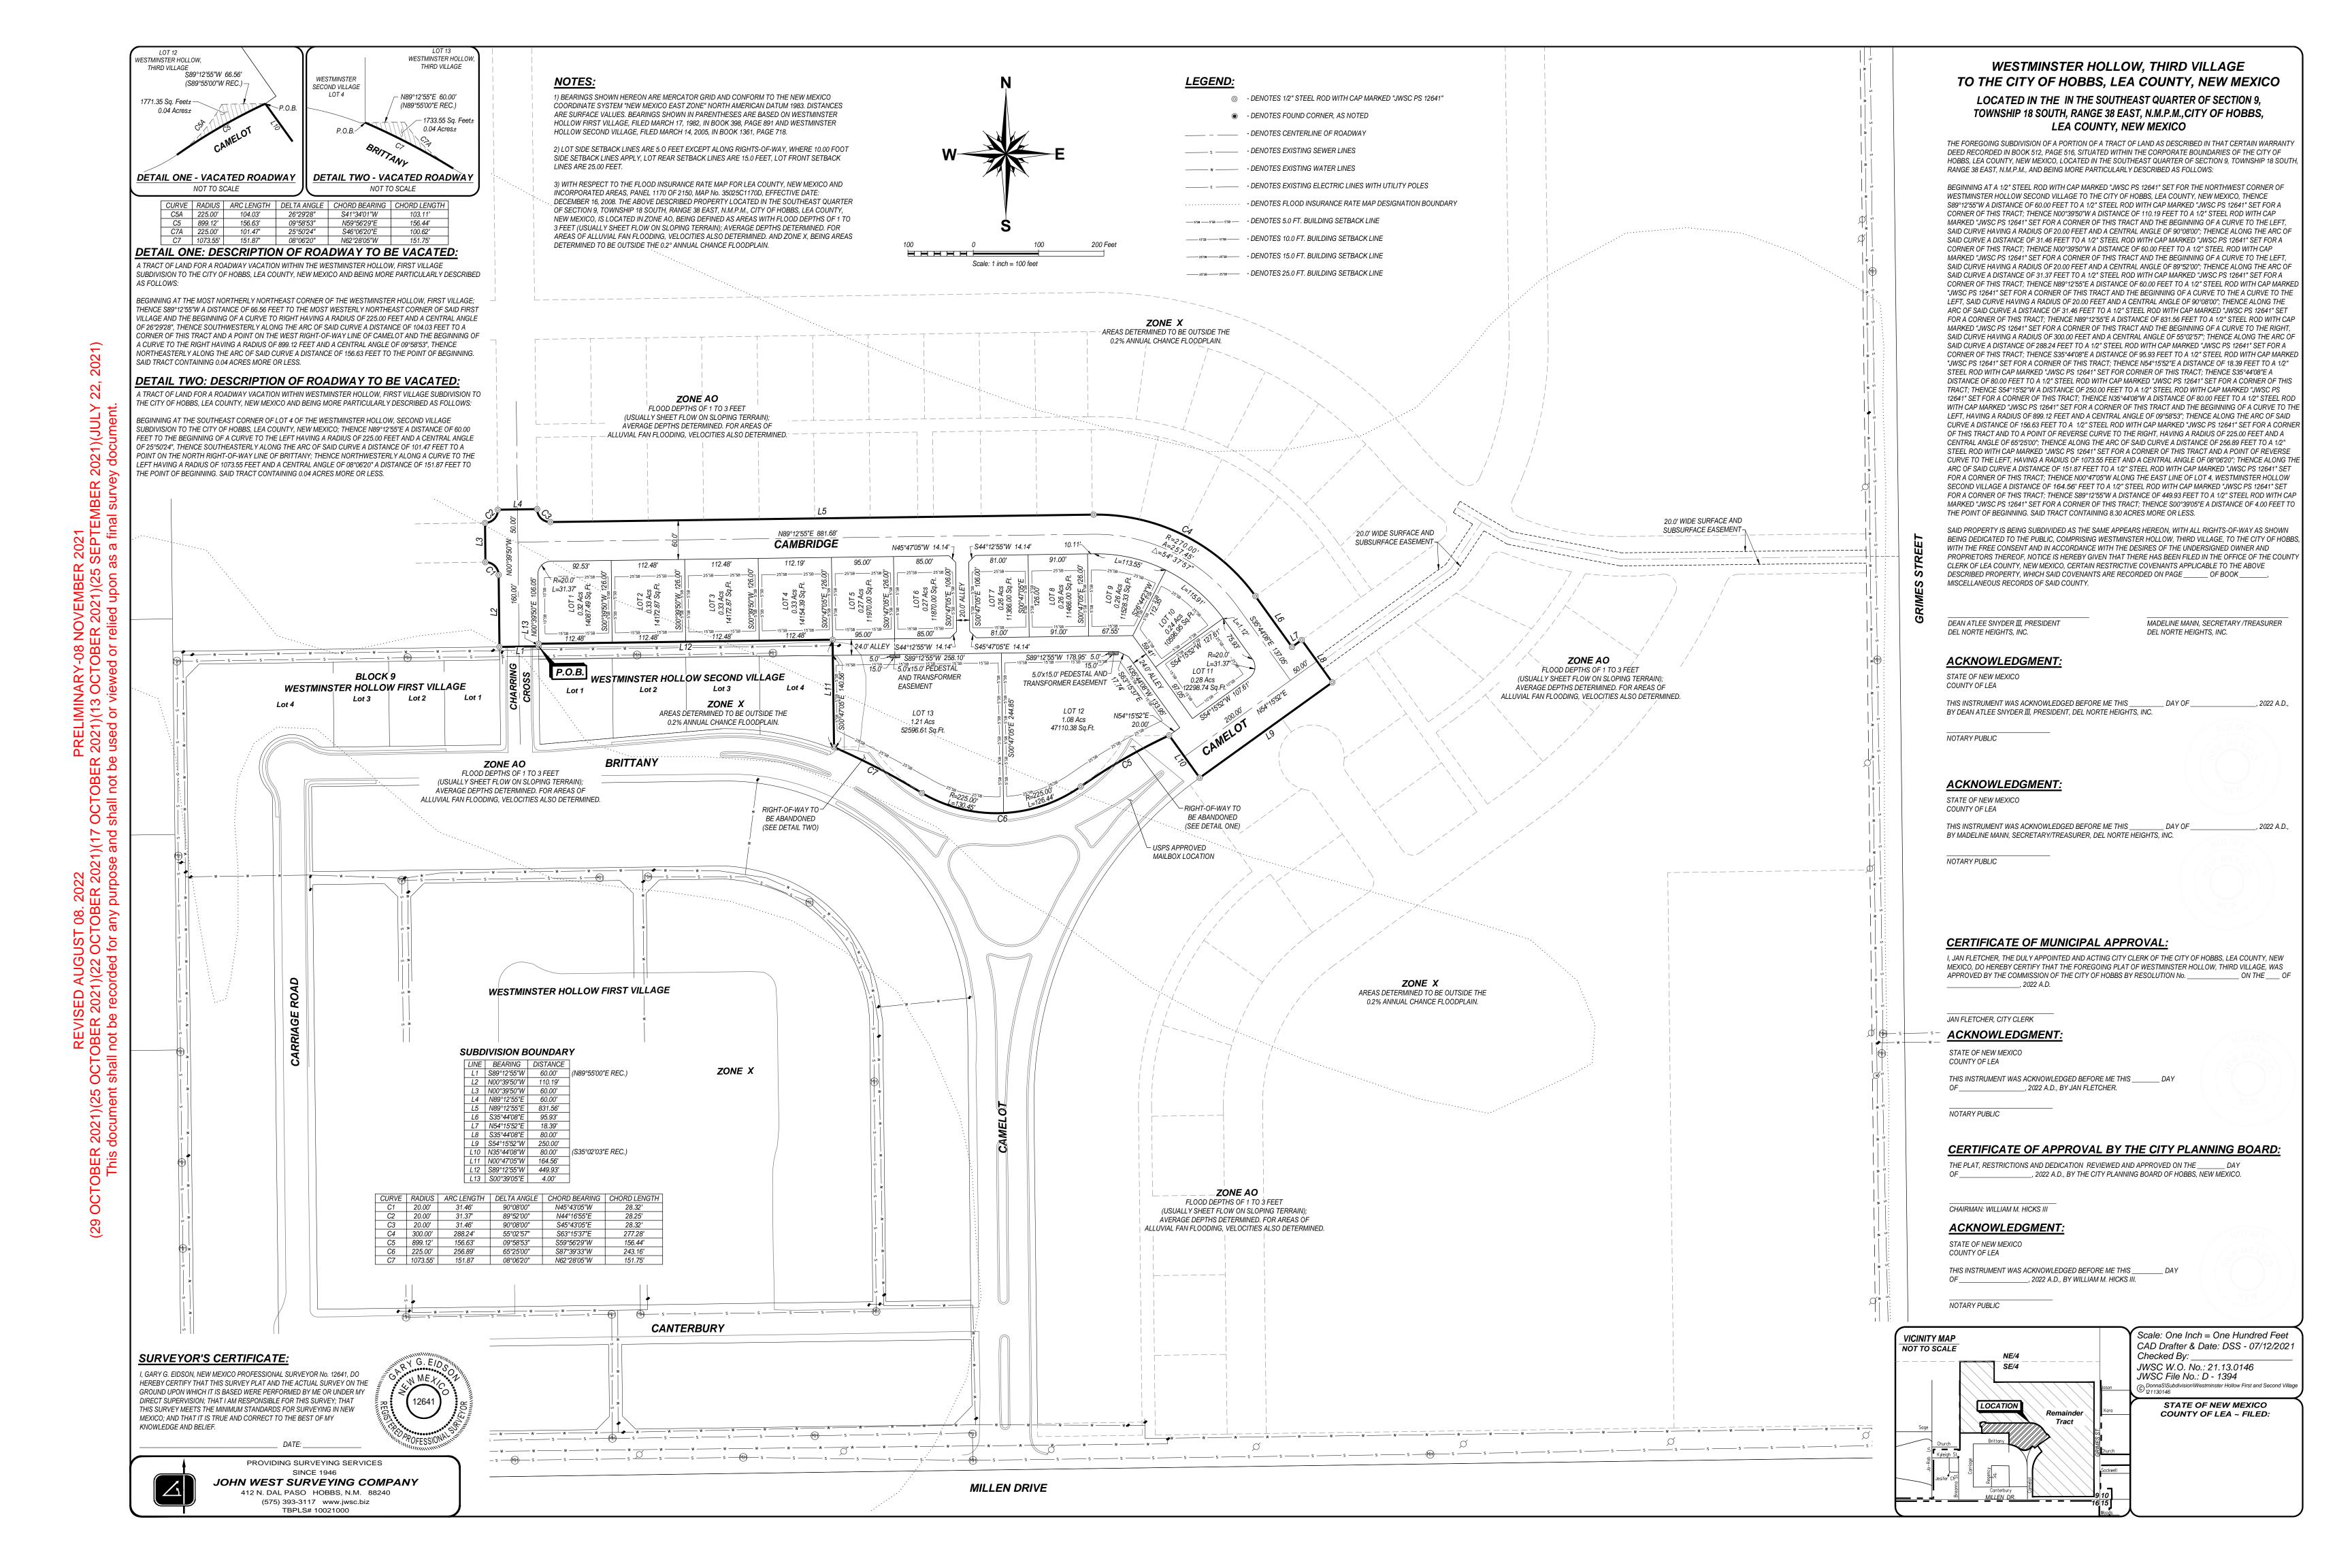

8) Review and Consider Variance Request from MC 15.32.030 - C(2) allowing a new facade sign to be emplaced with a sign face in excess of 144 square feet at 5440 A Street.



HOBBS, NM

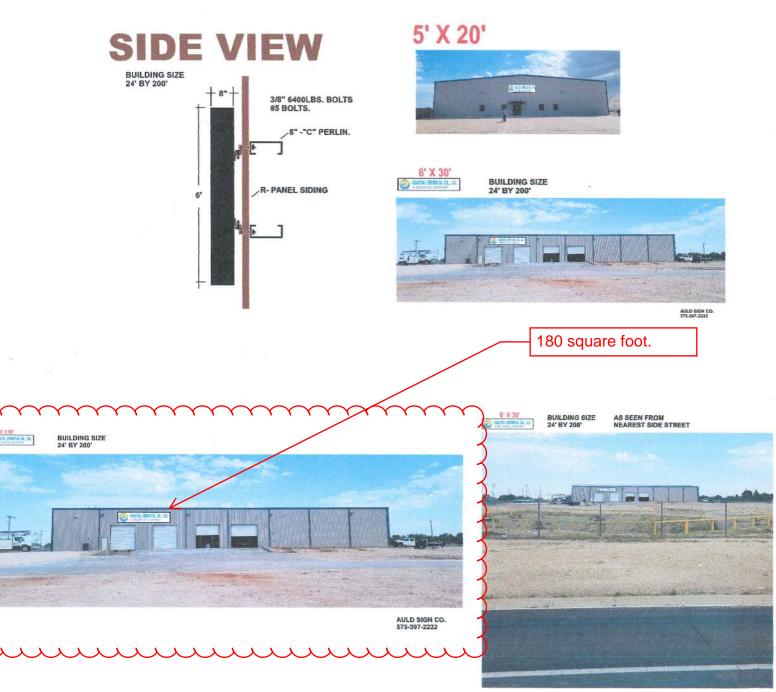

9) Review and Consider a front yard fence height variance for 205 E. Navajo. Navajo at this location is classified as a Major Arterial and exceeds the required ROW width of 110'. The COHMTP requires a 25' front yard setback for fences on a Major Arterial, the new Fence is proposed to be a 6' Cedar Picket Fence located at the PL (+/-36' from BOC).

	TABLE 1 ARD REQUIREMENTS – S g Setback Line - From Street			P. State	VARIANCE REQUESTED:
Type of Street	Minimum Front Yard Mi Dimension From Front Fro	nimum Side Yard Dimension om Side Property Line			New wooden picket fence (6' tall)
Major Arterial Street Main Building Attached Garage Detached Accessory Bldg.	Property Line 40' NA 40'	40' NA 30'			Variance Requested: 0' Setback at common property line
Fence Landscaping Parking / On-Site	0 5'	10'-25' 0 0			Contact: Michael Mings Cell: 575-390-3304
A CONTRACTOR OF		10 pt		124-5	Email: mingsfamily@live.com
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NAVAJO RD.					isting 4' chain link ice at the common
- Land	E Navajo D				E Navajo Dr
			PERSONAL PROPERTY AND		Imagery Date: 2/20/2019 lat 32.740539° lot

DISCUSSION ITEMS

10) Review proposed Ordinance to prohibit on street parking of commercial vehicles.

TRUCK CLASSIFICATIONS



WikipediA

Truck classification

Truck classifications are typically based upon the maximum loaded weight of the truck (typically using the <u>gross</u> vehicle weight rating (GVWR) and sometimes also the <u>gross trailer weight rating</u> (GTWR), and can vary among jurisdictions.

Contents

United States Table of US GVWR classifications Notes on weight classes Canada European Union List of truck types Gallery See also References External links

United States

In the <u>United States</u>, commercial truck classification is determined based on the vehicle's gross vehicle weight rating (GVWR). The classes range from 1–8.^{[1][2]} Trucks are also classified more broadly by the <u>Department of Transportation's</u> Federal Highway Administration (FHWA), which groups classes 1–3 as *light duty*, 4–6 as *medium duty*, and 7–8 as *heavy duty* and a Commercial drivers license is generally required^{[1][3][4][5]} The <u>United States Environmental Protection Agency</u> has a separate system of emissions classifications for trucks.^{[1][6]} The <u>United States Census Bureau</u> also assigned classifications in its now-discontinued Vehicle Inventory and Use Survey (VIUS) (formerly Truck Inventory and Use Survey (TIUS)).^[7]

Table of US GVWR classifications

US truck class	Duty classification	Weight limit [1][8]	Examples
Class 1	Light truck	0–6,000 pounds (0–2,722 kg)	Dodge Dakota, Chevrolet Colorado/GMC Canyon, Toyota Tacoma, Nissan Frontier, Ford Ranger ^[9]
Class 2	Light truck	6,001–10,000 pounds (2,722– 4,536 kg)	Ram 1500, Chevrolet Silverado 1500, Ford F-150
Class 3	Light truck	10,001–14,000 pounds (4,536– 6,350 kg)	Ram 3500, GMC Sierra 3500, Ford E-350, Ford F-350, Hummer H1
Class 4	Medium truck	14,001–16,000 pounds (6,351– 7,257 kg)	Ram 4500, <u>GMC 4500</u> , <u>Ford E-450</u> , <u>Ford F-450</u> ^[9] , <u>HINO 155</u> <u>COE</u> ^[10]
Class 5	Medium truck	16,001–19,500 pounds (7,258– 8,845 kg)	Ram 5500, GMC 5500, Ford F-550, Peterbilt 325, International TerraStar ^[11] , HINO 195 COE ^[12]
Class 6	Medium truck	19,501–26,000 pounds (8,846– 11,793 kg)	Chevrolet Kodiak C6500, Ford F-650, Peterbilt 330, International Durastar ^[13] , HINO 268 & 268A ^[14]
Class 7	Heavy truck	26,001–33,000 pounds (11,794– 14,969 kg)	Autocar ACMD, GMC C7500, Peterbilt 220 & 337, Ford F-750 ^[15] , HINO 338 ^[16]
Class 8	Heavy truck	33,001 pounds (14,969 kg)+	Autocar ACX, International WorkStar, Kenworth T600, Kenworth T660, Kenworth T680, Peterbilt 579, Peterbilt 389 ^[17] - Semi-trailer trucks fall into this category
Class 9	Super-heavy / special duty truck	33,001 pounds (14,969 kg)+	Usually class 8 truck with special duty characteristics, e.g Autocar ACX 12x6, International WorkStar, Western Star 6900 (6900XD or 6900TS). ^{[18][19][20][21][22]}

Notes on weight classes

Class 2

Class 2 is subdivided into Class 2a ($\frac{1}{2}$ -ton) and Class 2b ($\frac{3}{4}$ -ton), with class 2a being 6,001–8,500 pounds (2,722– 3,856 kg), and class 2b being 8,501–10,000 pounds (3,856–4,536 kg). Examples of vehicles in Class 2b include the Ram 2500, <u>Chevrolet Silverado 2500</u>, and the <u>Ford F-250</u>. SUVs in Class 2b include the <u>Ford Excursion</u> and the <u>Chevrolet</u> <u>Suburban</u> 2500. Class 2a is commonly referred to as a light duty truck, with class 2b being the lowest heavy-duty class, also called the light heavy-duty class.^{[9][23][24]}

Medium duty ton rating

When light-duty trucks were first produced in the United States, they were rated by their <u>payload</u> capacity in <u>tons</u> (e.g., ¹/₂-, ³/₄- and 1-ton). Over time, payload capacities for most domestic pickup trucks have increased while the ton titles have stayed the same. The now-imprecise ton rating is presently used to compare standard sizes, rather than actual capacities.

This has led to categorizing trucks similarly, even if their payload is different. Therefore, the Toyota Tacoma, Dodge Dakota, Ford Ranger, Honda Ridgeline, Chevrolet S-10, GMC S-15 and Nissan Frontier are called quarter-tons (¼-ton). The Ford F-150, Chevrolet C10/K10, Chevrolet/GMC 1500, Dodge 1500, Toyota Tundra, and Nissan Titan are half-tons

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(¹/₂-ton). The Ford F-250, Chevrolet C20/K20, Chevrolet/GMC 2500, and Dodge 2500 are three-quarter-tons (³/₄-ton). Chevrolet/GMC's ³/₄-ton suspension systems were further divided into light and heavy-duty, differentiated by 5-lug and 6 or 8-lug wheel hubs depending on year, respectively. The Ford F-350, Chevrolet C30/K30, Chevrolet/GMC 3500, and Dodge 3500 are one tons (1-ton).

Similar schemes exist for vans and SUVs (e.g. a 1-ton Dodge Van or a ½-ton GMC Suburban), medium duty trucks (e.g. the Ford 1½-ton F-450) and some military vehicles, like the ubiquitous deuce-and-a-half.

Class 7

Vehicles in Class 7 and above require a Class-B commercial driver's license (CDL) to operate in the United States.

Class 8

The Class 8 truck gross vehicle weight rating (GVWR) is a vehicle with a GVWR exceeding 33 000 lb (14 969 kg).^{[1][25]} These include tractor trailer tractors as well as single-unit dump trucks of a GVWR over 33,000 lb; such trucks typically have 3 or more axles. The typical 5-axle tractor-trailer combination, also called a "semi" or "18-wheeler", is a Class 8 vehicle. Standard trailers vary in length from 8' containers to 57' van trailers, with the most common length being the 53' trailer. Specialized trailers for oversized loads can be considerably longer. Commercial operation of a Class 8 vehicle in the United States requires either a Class-B CDL for non-combination vehicles, or a Class-A CDL for combination vehicles (tractor-trailers).

The practical gross vehicle weight limit in the USA for Class 8 trucks is determined by per-axle weight limits set by the <u>Federal Bridge Gross Weight Formula</u> on interstate highways. Longer 18-wheelers can weigh up to 80,000 lbs. In most states, exceptions to these limits can be made for an <u>Oversize load</u> but they require special permits and handling on a designated route.

Class 9/Super heavy duty

Usually classifies a heavy, special duty Class 8 truck. For example the <u>Western Star</u> 6900 is designed for <u>off-highway</u> vocations including logging, mining, and other similar applications.

Canada

Vehicle classifications vary among provinces in Canada, due to "differences in size and weight regulations, economic activity, physical environment, and other issues".^{[26]:3} While several provinces use their own classification schemes for traffic monitoring, <u>Manitoba</u>, <u>Ontario</u>, <u>Prince Edward Island</u> and <u>Saskatchewan</u> have adopted the 13-class system from the United States' <u>Federal Highway Administration</u>—sometimes with modifications, or in Ontario's case, for limited purposes.^{[26]:3-4} <u>British Columbia</u> and Ontario also distinguish between short- and long-combination trucks.^{[26]:3-4} In accident reporting, eight jurisdictions subdivide trucks by GVWR into light and heavy classes at approximately 4 500 kg 9 921 lb.^{[26]:6}

European Union

In the European scheme the licenses are (among others) **B** for cars, **C** for trucks (lorries), **D** for buses, and are limited by the GVWR.

Divides into two types:

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1. appending a number to the class denotes the "light" versions of said class.

2. appending the letter E allows for larger trailers (GTWR).

Class B permits the use of vehicles with GVWRs of not more than 3 500 kg and a trailer with GTWRs not exceeding 750 kg, or a trailer above said limit, if the gross weight of car and trailer combined does not exceed 3 500 kg (or 4 250 kg after a theoretical and practical course of 7 hours). Such vehicles are also commonly known as light commercial vehicles (LCVs), and include the Ford Transit, Mercedes-Benz Sprinter and Fiat Ducato.

Class BE allows for trailers up to 3 500 kg GTWR while driving a class B vehicle.

Class C1 raises the GVWR limit to 7 500 kg and a trailer of GTWR not exceeding 750 kg.

Class C removes the GVWR limit, but the GTWR limit for the trailer of 750 kg stays.

Class C1E allows for a class B or C1 vehicle and a trailer of more than 750 kg GTWR, if the combined gross weight does not exceed 12 000 kg.

Class CE removes the trailers GTWR limit while driving a Class C vehicle.

List of truck types

- Truck (Lorry) See List of truck types
 - Box truck
 - Cab forward
 - Chassis cab
 - Conversion van
 - Flatbed truck
 - Logging truck
 - Panel van

Gallery



Platform truck

- Sport utility vehicle
- Tractor unit (Semi tractor)
- Tow truck
- Van



Class 1 Light duty Toyota Tacoma

Class 2 2001 Ford Excursion 4×4 (GVWR: 8,600 pounds (3.9 t)



Class 3 Ford F-350



Class 4 2008 Ford F-450 4×4 Class 5 2005 Chevy Kodiak pick-up truck (GVWR: 14,500 4×4 (GVWR: 17,500 pounds pounds (6.6 t))



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Class 6 2002 Ford F-650 in front (GVWR: Class 7 Peterbilt 330 dump truck. 26 000 lb), 1989 Ford F-600 in back (GVWR: 20,200 pounds (9.2 t)





Class 8 Kenworth W900 tractor with spread- Class 9 Western Star 6900XD tractor. axle 48 feet (15 m) refrigerated trailer.

See also

- Car classification
- Corporate Average Fuel Economy (CAFE)
- Commercial vehicle .
- Curb weight
- Driver's license •
- Gross weight: .
 - Gross axle weight rating (GAWR)
 - Gross combined weight rating (GCWR)
 - Gross trailer weight rating (GTWR)
 - Gross vehicle weight rating (GVWR)
- Large goods vehicle
- List of truck types
- Tow hitch
- Trailer .
- Vehicle category

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External links

- Reducing CO2 emissions from Heavy-Duty Vehicles (http://ec.europa.eu/clima/policies/transport/vehicles/heavy/index _en.htm) (European Union).
- Source in german (https://www.help.gv.at/Portal.Node/hlpd/public/content/4/Seite.040150.html)

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